
Canyon County, ID Web Map

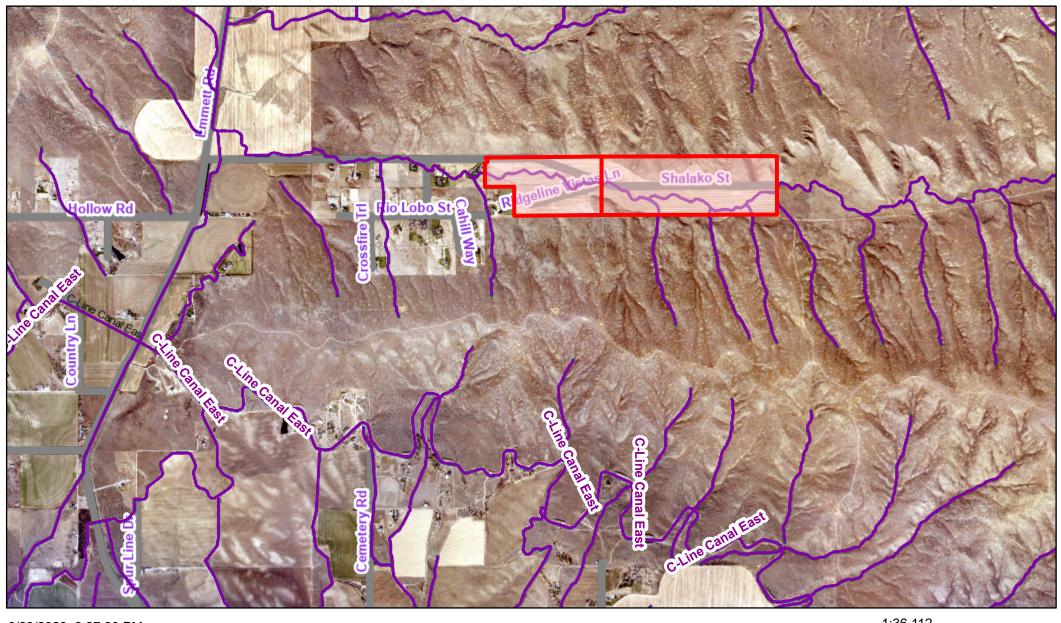



MASTER APPLICATION

CANYON COUNTY DEVELOPMENT SERVICES DEPARTMENT


111 North 11th Avenue, #140, Caldwell, ID 83605

www.canyonco.org/dsd.aspx Phone: 208-454-7458 Fax: 208-454-6633



Barra d'

	OWNER NAME: Ridgeline Vistas, LLC										
PROPERTY	MAILING ADDRESS: 2150 W. Pacific Ridge, Eagle, ID 83616										
OWNER	PHONE: (208) 869-9760 EMAIL: mdrown42@gmail.com										
I consent to this	application and allow DSD staff / commissioners to enter the property for site inspections. If owner(s) are a business entity, please include business documents, including those that indicate the person(s) who are eligible to sign.										
Signature:	Date: 10/27/2021										
(AGENT)	CONTACT NAME: Kevin McCarthy / Stephanie Hopkins										
ARCHITECT	COMPANY NAME: KM Engineering, LLP										
ENGINEER BUILDER	MAILING ADDRESS: 5725 N. Discovery Way, Boise, ID 83713										
	PHONE: (208) 639-6939 EMAIL: kevin@kmengllp.com shopkins@kmengllp.com										
	STREET ADDRESS: 0 Shalako St., & 0 Emmett Rd., Middleton, ID 83644										
	PARCEL #: R3736900000 & R3736800000 LOT SIZE/AREA: 190.72 AC										
SITE INFO	LOT: BLOCK: SUBDIVISION:										
	QUARTER: $\begin{array}{cccccccccccccccccccccccccccccccccccc$										
9 -	ZONING DISTRICT: CR-R-R FLOODZONE (YES/NO): Yes										
HEARING	CONDITIONAL USECOMP PLAN AMENDMENTCONDITIONAL REZONE										
LEVEL	ZONING AMENDMENT (REZONE)DEV. AGREEMENT MODIFICATIONVARIANCE > 33%										
APPS	MINOR REPLATVACATIONAPPEAL										
_	SHORT PLAT SUBDIVISION X PRELIMINARY PLAT SUBDIVISIONFINAL PLAT SUBDIVISION										
DIRECTORS	ADMINISTRATIVE LAND DIVISIONEASEMENT REDUCTIONSIGN PERMIT										
DECISION	PROPERTY BOUNDARY ADJUSTMENTHOME BUSINESSVARIANCE 33% >										
APPS	PRIVATE ROAD NAMETEMPORARY USEDAY CARE										
	OTHER										
CASE NUMBE	R: DATE RECEIVED:										
RECEIVED BY	APPLICATION FEE: CK MO CC CASH										

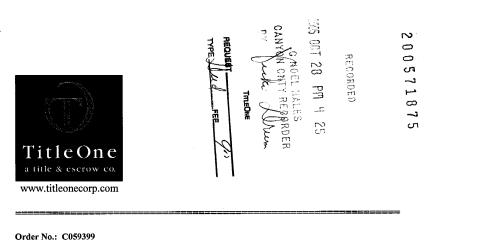

CORPORATION WARRANTY DEED

For Value Received: JADE EAGLE, INC..

A Corporation duly organized and existing under the laws of the State of IDAHO hereby Grant, Bargain, Sell and Convey unto RIDGELINE VISTAS, LLC., AN IDAHO LIMTED LIABILITY COMPANY,

Hel

Whose current address is: 533 E RIVERSIDE DR., STE 110, EAGLE, ID 83616

The following described real estate, to wit:

SEE ATTACHED LEGAL DESCRIPTION MARKED EXHIBIT "A", WHICH BY THIS REFERENCE DECOMES A PART THEREOF AND CONSISTS OF TWO (2) PAGES.

TO HAVE AND TO HOLD the said premises, with their appurtenances unto the said Grantee, heirs and assigns forever.

The Grantor does hereby covenant to and with the said Grantees, that it is the owner in fee simple of said premises; that it is free from all encumbrances, EXCEPT those to which this conveyance is expressly made subject and those made, suffered or done by the Grantee: and subject to restrictions, dedications, easements, rights of way and agreements, (if any) of record, and general taxes and assessments, including irrigation and utility easements, (if any) for the current year, which are not due and payable, and that Grantor will warrant and defend the same from all lawful claims whatsoever. In constraining this Deed and where the context so requires, the singular includes the plural, and the masculine, includes the feminine and neuter.

IN WITNESS WHEREOF, the Grantor, pursuant to a resolution of its Board of Directors has caused its corporate name to be hereunto subscribed.

Dated: 10/28/05

JADE EAGLE INC., by:

RICHARD O. THURBER, It's PRESIDENT

STATE OF IDAHO

COUNTY OF ADA

ON THIS \mathcal{J} DAY OF OCTOBER IN THE YEAR 2005, BEFORE ME, THE UNDERSIGNED, A NOTARY PUBLIC IN AND FOR SAID STATE PERSONALLY APPEARED, RICHARD O. THURBER KNOWN TO ME TO BE THE PRESIDENT OF THE CORPORATION THAT EXECUTED THIS INSTRUMENT AND THE PERSON WHO EXECUTED THE INSTRUMENT ON BEHALF OF SAID CORPORATION, AND ACKNOWLEDGED TO ME THAT SUCH CORPORATION EXECUTED THE SAME.

IN WITNESS WHEREOF, I HAVE HEREUNTO SET MY HAND AND AFFIXED MY OFFICIAL SEAL THE DAY AND YEAR IN THIS CERTIFICATE FIRST ABOVE WRITTEN.

DIANNA L. STORK

RESIDING AT: MERIDIAN

MY COMMISSION EXPIRES ON:01/23/

CANYON, ID

EXHIBIT "A"

PARCEL 1:

Part of the Southeast Quarter of the Section 6 and the Southwest Quarter of Section 5 and the Southwest Quarter of the Southeast Quarter of Section 5, Township 5 North, Range 2 West, of the Boise Meridian, Canyon County, Idaho, described as follows:

COMMENCING at a brass cap monument marking the Southwest corner of Section 6, Township 5 North, Range 2 West, of the Boise Meridian, Canyon County, Idaho, and running thence

North 89°32'55" East 2606.07 feet, said point being the South Quarter corner of said Section 6; thence North 0°02'05" West 660.18 feet to the POINT OF BEGINNING; thence

North 0°02'05" West 538.36 feet to a point of curve with a radius of 60.00 feet, a central angel of 180°00'00" and a chord that bears North 00°02'05" West 120.00 feet; thence to the left along said curve 188.49 feet; thence North 89°38'18" East 1320.00 feet to a brass cap marking the Southeast One-Sixteenth (1/16) corner of said

North 89°35'50" East 1323.33 feet to a brass cap marking the South One-Sixteenth (1/16) corner of said section; thence

North 89°58'32" East 2644.82 feet; thence

North 89°56'52" East 1323.59 feet thence

South 0°08'58" East 1319.92 feet; thence

South 89°57'54" West 1324.20 feet to the South Quarter corner of said Section 5; thence

South 89°45'55" West 2648.40 feet to the Southwest corner of said Section 5; thence

South 89°51'00" West 1981.32 feet; thence

North 0°03'14" West 660.58 feet; thence

South 89°48'56" West 660.21 feet to the POINT OF BEGINNING.

Being Lot 14, High Plains Estates, of Record of Survey, recorded April 21, 2004, as Instrument No. 200421334, records of Canyon County, Idaho.

PARCEL 2:

A 60-foot wide right-of-way to be used for ingress-egress and utilities lying in the Southeast Quarter of Section 1, Township 5 North, Range 3 West of the Boise Meridian, the South half of Section 6, Township 5 North, Range 2 West of the Boise Meridian and the North half of Section 7, Township 5 North, Range 2 West of the Boise Meridian described as follows:

Beginning at a brass cap monument marking the Southeast 1/16 corner of Section 1 Township 5 North, Range 3 West of the Boise Meridian and running thence North 89°53'06" East 1316.24 feet to a brass cap monument marking the South 1/16 corner of said Section 1; thence North 89°51 '15" East 1286.78 feet to a brass cap monument marking the Southwest 1/16 corner of Section 6, Township 5 North, Range 2 West of the Boise Meridian; thence North 89°41'07" East 1319.08 feet to a brass cap monument marking the center South 1/16 corner of said Section 6; said point being a point of curve with a radius of 60.00 feet, a central angle of 255°44'17" and a chord that bears South 37°35'11" West 95.05 feet; thence to the right along said curve 267.81 feet to a point of reverse curve with a radius of 20.00 feet, a central angle of 75°31 '21" and a chord that bears North 52°33'13" West 24.49 feet; thence to the left along said curve 26.36 feet; thence South 89°41'07" West 1160.53 feet to a point of curve with a radius of 50.00 feet, a central angle of 90°24'59" and a chord that bears South 44°28'37" West 70.97 feet; thence to the left along said curve 78.90 feet; thence South 0°43'52" East 1101.4 7 feet to a point of curve with a radius of 50.00 feet, a central angle of 89°43'13" and a chord that bears South 45°35'29" East 70.54 feet; thence to the left along said curve 78.30 feet; thence North 89°32'55" East 1224.01 feet; thence North 89°51'00" East 2641.63 feet; thence South 0°09'00" East 60.00 feet to a 5/8" iron rod with yellow plastic cap marked P.L.S. 7323 marking the Southeast corner of said Section 6; thence South

Exhibit "A"
Legal Description

Document: DED WAR 2005.71875

CANYON.ID

89°51'00" West 2641.75 feet to a 5/8" iron rod with yellow plastic cap marked P.L.S. 7323 marking the South Quarter corner of said Section 6; thence South 89°32'55" West 587.02 feet to a point of curve with a radius of 50.00 feet, a central angle of 101 °35'06" and a chord that bears South 38°45'22" West 77.49 feet; thence to the left along said curve 88.65 feet; thence South 12°02'11" East 194.45 feet; thence South 2°50'01" East 185.61 feet; thence South 10°07'32" East 211.90 feet to a point of curve with a radius of 60.00 feet, a central angle of 255°31'21" and a chord that bears North 62°21'52" West 94.87 feet; thence to the right along said curve 267.58 feet to a point of reverse curve with a radius of 20.00 feet, a central angle of 75°31 '21" and a chord that bears North 27°38'08" East 24.49 feet; thence to the left along said curve 26.36 feet; thence North 1 0°07'32" West 138.27 feet; thence North 2°50'01" West 184.60 feet; thence North 12°02'11" West 222.42 feet to a point of curve with a radius of 50.00 feet, a central angle of 78°24'54" and a chord that bears North 51 °14'38" West 63.21 feet; thence to the left along said curve 68.43 feet; thence South 89°32'55" West 1746.08 feet to a point of curve with a radius of 50.00 feet, a central angle of 89°35'08" and a chord that bears South 44°45'21" West 70.45 feet; thence to the left along said curve 78.18 feet; thence South 0°02'13" East 485.13 feet to a point of curve with a radius of 20.00 feet, a central angle of 75°31'21" and a chord that bears South 37°47'54" East 24.49 feet; thence to the left along said curve 26.36 feet to a point of reverse curve with a radius of 60.00 feet, a central angle of 255°31 '21" and a chord that bears South 52°12'06" West 94.87 feet; thence to the right along said curve 267.58 feet; thence North 0°02'13" West 611.80 feet to a brass cap monument marking the Southwest corner of said Section 6; thence North 89°55'43" West 658.93 feet to a point of curve with a radius of 60.00 feet, a central angle of 243°01'43" and a chord that bears North 31°31'17" East 102.30 feet, thence to the right along said curve 254.50 feet to a point of reverse curve with a radius of 50.00 feet, a central angle of 62°57'52" and a chord that bears South 58°26'48" East 52.22 feet; thence to the left along said curve 54.95 feet; thence North 89°42'46" East 1782.95 feet to a point of curve with a radius of 50.00 feet, a central angle of 90°16'46" and a chord that bears North 44°24'31" East 70.88 feet; thence to the left along said curve 78.78 feet; thence North 0°43'52" West 1102.09 feet to a point of curve with a radius of 50.00 feet, a central angle of 89°24'52" and a chord that bears North 45°26'18" West 70.35 feet; thence to the left along said curve 78.03 feet; thence South 89°51'15" West 1208.02 feet; thence South 89°53'06" West 1316.31 feet; thence North 0°02'31" East 60.00 feet to the point of beginning.

Exhibit "A" Legal Description

CANYON, ID



October 27, 2021 Project No. 18-168

Mr. Dan Lister Planning Official Canyon County Development Services 111 North 11th Avenue Caldwell, Idaho 83605

RE: Ridgeline Vistas – Canyon County Preliminary Plat

Dear Mr. Lister:

On behalf of Ridgeline Vistas, LLC, we are pleased to submit the attached application and required supplements for a preliminary plat for the Ridgeline Vistas Subdivision.

Site & Background Information

The subject property is comprised of two parcels (Parcel Nos. R3736900000 and R3736800000) and is approximately 190.72 acres in total. The site is located in Canyon County a little over a mile east of Emmett Road, and will take access via Shalako Street. The property recently received approval for a conditional rezone from Agricultural to Rural Residential (CR2020-0012). That approval included a development agreement that limits the development to no more than 20 buildable lots with an average lot size of 8.5 acres in accordance with the associated concept plan.

Preliminary Plat

The attached preliminary plat for Ridgeline Vistas includes a total of 20 buildable lots on approximately 190.72 acres. The layout reflects an overall density of 0.11 units per gross acre with an average lot size of 8.97 acres, both of which are consistent with the development agreement and CR-R-R zoning district standards.



The site will take access from and connect to High Plains Estates to the west via Shalako Street, an existing private road. Shalako Street will continue into the site as an internal private right-of-way that will be stubbed to the east. One private cul-de-sac (W. Ridgeline Vistas Court) is proposed to serve as internal access for four residential lots. All internal roads will include 60' of right-of-way with a 24' pavement section per Canyon County requirements.

Lots within Ridgeline Vista Subdivision will utilize private domestic wells and septic systems for water and sewer service. As necessary, we will coordinate with the Southwest District Health Department and Idaho Department of Environmental Quality regarding individual septic system and drain field requirements as individual lot development progresses.

A portion of Lots 1-4, Block 1 contain Flood Zone A as depicted on the preliminary plat. At this time, development is not contemplated within this area and building envelopes have been identified on the preliminary engineering plans indicating that development is to occur outside the floodplain.

Development Agreement Conditions

The rezone approval included a number of conditions that were required to be addressed with the preliminary plat submittal. Those conditions have been addressed as follows.

- Condition 2a: The preliminary plat is in substantial compliance with the approved concept plan.
- Condition 2b: At this time the project has been configured such that residential development will not occur in

areas with slopes greater than 15%. If during final design we impact slopes greater than 15% we

will comply with Canyon County requirements for hillside development.

Condition 2c: A biological assessment has been prepared indicating that the proposed development is not

expected to generate any mitigation needs. A copy of the assessment is included with this application and has also been submitted to the Idaho Department of Fish and Game for review

as required.

Condition 2d: The developer will work with the school district regarding school bus transportation issues and

resolutions will be presented with the final subdivision plat.

Condition 2e: To preserve agricultural uses, each lot will have a building envelope no greater than 2 acres for

the location of all residential and agricultural structures. This is noted on the preliminary plat and will also be noted on the final plat. Final building envelope locations will be determined by the

individual lot owners upon development of each lot.

Conclusion

With the proposal discussed herein, we believe that the Ridgeline Vistas project complements surrounding rural residential uses, is consistent with the existing High Point Estates neighborhood and will provide additional housing opportunities for this beautiful area of Canyon County.

Should you have questions or require further information in order to process this application, please feel free to contact me.

Sincerely,

KM Engineering, LLP

Kevin McCarthy, P.E.

Principal

cc: Ridgeline Vistas, LLC

Mr. Matt Drown

PRELIMINARY PLAT SUBMITTAL LIST

CANYON COUNTY DEVELOPMENT SERVICES DEPARTMENT

111 North 11th Avenue, #140, Caldwell, ID 83605

www.canyonco.org/dsd.aspx Phone: 208-454-7458 Fax: 208-454-6633



THE FOLLOWING ITEMS MUST BE SUBMITTED WITH THIS CHECKLIST:

X	Master Application completed and signed
X	Irrigation Plan see included memo from SPF Water Engineering
X	Detailed letter fully describing the request or project, include total number of lots, buildable lots, open space lots, size of lots, improvements and how you will mitigate adverse impacts
X	Subdivision Worksheet
X	Private Road Name application (if internal roads are private)
n₫	Easement reduction application (if requesting an easement width less than 60 feet)
X	Preliminary Drainage Plan
n₫	Preliminary Irrigation Plan
⊠	Preliminary Grading plan
X	Copy of Preliminary Plat
X	Deed or evidence of property interest to all subject properties.
X	\$1440 + \$10/lot +\$100 (if in a city area of impact) non-refundable fee

NOTES:

- 1. After the plat is reviewed and found to be in compliance, an additional five (5) copies and one electronic version of the final plat shall be submitted.
- 2. It is highly recommended you approach Idaho Department of Water Resources and Southwest District Health to have a pre-application regarding your proposed development meeting prior to submittal to this department.

PROCESS: PUBLIC HEARING









STATE OF IDAHO

Office of the secretary of state, Lawerence Denney ANNUAL REPORT

Idaho Secretary of State PO Box 83720 Boise, ID 83720-0080 (208) 334-2301 Filing Fee: \$0.00 For Office Use Only

-FILED-

File #: 0003996339

Date Filed: 9/4/2020 9:11:30 AM

Entity Name and Mailing Address:

Entity Name: RIDGELINE VISTAS, LLC

The file number of this entity on the records of the Idaho Secretary 0000142076

of State is:

Address 2150 W PACIFIC RIDGE ST EAGLE, ID 83616-3578

Entity Details:

Entity Status Active-Existing

This entity is organized under the laws of: IDAHO

If applicable, the old file number of this entity on the records of the W43355

Idaho Secretary of State was:

The registered agent on record is:

Registered Agent MATTHEW DROWN Registered Agent

Physical Address

2150 W PACIFIC RIDGE EAGLE, ID 83616

Mailing Address

Limited Liability Company Managers and Members

Name	Title	Business Address				
+ Matthew C Drown	Manager	2150 W PACIFIC RIDGE ST. EAGLE, ID 83616				

The annual report must be signed by an authorized signer of the entity.

Matthew C Drown 09/04/2020

Sign Here Date

Job Title: Manager

SITE PLAN & LETTER OF INTENT - CHECKLIST

CANYON COUNTY DEVELOPMENT SERVICES DEPARTMENT

111 North 11th Avenue, #140, Caldwell, ID 83605

www.canyonco.org/dsd.aspx Phone: 208-454-7458 Fax: 208-454-6633



The site plan is a detailed GRAPHICAL description of existing and proposed site features. Include all applicable items on your site plan: All existing and proposed structures and dimensions (i.e. 40'X30' shop, 20'x20' shed, 40'x50' house, 10'

windmill, etc.)
☑ Infrastructure: well, septic, irrigation ditch, settling ponds, drainage swales, etc.
r ☐a Transportation: parking, loading areas, driveways, etc. adjacent driveways, roads, highways or other accesses
Easement locations and dimensions
☑ Setbacks from property lines, section lines, collectors and arterial roads and/or building envelope
☐ Areas of steep slopes, wetlands, and/or floodplain
☑ Existing or proposed fences
☑ Signs
Major landscaping or hardscaping, such as large trees, berms, or retaining walls, water features
n☑aAreas of activity, outdoor seating, food vendor area, stockpiling, open pit, etc.
Any other site features worth noting
The Letter of Intent is a detailed WRITTEN description of proposed and existing uses at the site. Include all applicable items in your letter:
A description of the proposed use and existing uses
☑ A description of the proposed request and why it is being requested
nDa Expected traffic counts and patterns
☐ Phasing of development
☐ How proposed use may affect neighboring uses
A description or further explanation of the site features (see site plan list above)
n \square aExplanation of any other permits through other agencies that may be required
n ☑a Description of business operations, such as number of employees, hours of operation, delivery and shipping
A description of how the proposed use is consistent with specific zoning criteria or comprehensive plan policies
Any other items which may require further explanation

IRRIGATION PLAN APPLICATION

CANYON COUNTY DEVELOPMENT SERVICES DEPARTMENT

111 North 11th Avenue, #140, Caldwell, ID 83605

www.canyonco.org/dsd.aspx Phone: 208-454-7458 Fax: 208-454-6633



	Ridgeline Vistas, LLC	(208) 869-9760									
Applicant(s)	Name 2150 W. Pacific Ridge	Daytime Telephone No Eagle, ID									
	Street Address	City, State	Zip								
	SPF Water Engineering, ((208)384-4140, TScanlan@SP:	Fwater.com								
Representative		ytime Telephone Number / E-mail Address Ste. 350 Boise, ID 83706									
	Street Address	City, State	Zip								
Location of Subj	0 Shalako St., & 0 E	Emmett Rd., Middleton, ID	83644								
·	Two Nearest Cross Streets	s or Property Address	City								
Assessor's Accor	unt Number(s): R R3736900000 & R3736800	Section $\frac{5/6}{}$ Township $\frac{5N}{}$	Range $2\overline{\mathbb{W}}$								
This land:											
X	Has water rights available to it.										
	Is dry and has no water rights available to it. If dry, please sign this document and return to the Development Services Department representative from whom you received it.										

Idaho Code 31-3805 states that when all or part of a subdivision is "located within the boundaries of an existing irrigation district or canal company, ditch association, or like irrigation water delivery entity ... no subdivision plat or amendment to a subdivision plat or any other plat or may recognized by the city or county for the division of land will be accepted, approved, and recorded unless:"

- a. The appropriate water rights and assessment of those water rights have been transferred from said lands or excluded from an irrigation entity by the owner; or
- b. The owner, person, firm, or corporation filing the subdivision plat or amendment to a subdivision plat or map has provided underground tile or conduit for lots of one (1) acre or less, or a suitable system for lots of more than one (1) acre which will deliver water to those land owners within the subdivision who are also within the irrigation entity with the appropriate approvals:
 - 1. For proposed subdivisions located within negotiated area of city impact, both city and county zoning authorities must approve such irrigation system in accordance with Idaho Code Section 50-1306. In addition, the irrigation entity charged with the delivery of water to said lands must be advised regarding the irrigation system.

2. For proposed subdivisions outside of negotiated areas of city impact, the delivery system must be approved by the Planning and Zoning Commission and the Board of County Commissioners with the advice of the irrigation entity charged with the delivery of water to said lands.

To better understand your irrigation request, we need to ask you a few questions. A list of the map requirements follows the short questionnaire. Any information missing information may result in the delay of your request before the Planning and Zoning Commission and ultimately the approval of your irrigation plan by the Board of County Commissioners.

1.	Are you within an area of negotiated City Impact? Yes X _ No If yes, please include a copy of approvals by the City Planning & Zoning Commission and City Council of your Irrigation Plan.
2.	What is the name of the irrigation and drainage entities servicing the property?
	Irrigation: $^{ m NA}$
	Drainage: NA
3.	How many acres is the property being subdivided? $\underline{190.72}$
	What percentage of this property has water? 56% (107 acres)
	How many inches of water are available to the property? 2.14 cfs
6.	How is the land <u>currently</u> irrigated? Sprinkler Surface Irrigation Well Underground Pipe
7.	How is the land to be irrigated <u>after</u> it is subdivided? Surface Irrigation Well Above Ground Pipe Underground Pipe
	Please describe how the head gate/pump connects to the canal and irrigated land and where ditches and/or pipes go. Please see memo from SPF Water Engineering included with this application
10	Are there irrigation easement(s) on the property? Yes No How do you plan to retain storm and excess water on each lot? The lots are a minimum of 8 acres in size and will be graded to contain the storm water on-site.
_	
2	. How do you plan to remove the storm water /excess irrigation water prior to it entering the established drainage system? (i.e. oil, grease, contaminated aggregates) Storm water from the private roads will be contained in borrow ditches. Historical drainage features will be preserved through the site.
	itacorrear aramage reacures with be preserved chrough the site.

======================================	=======================================
I, the undersigned, agree that prior to the Development Services Dep to have all of the required information and site plans.	partment accepting this application I am responsible
I further acknowledge that the irrigation system, as approved by the Board of County Commissioners, must be bonded and/or install	
Signed: Property Owner	Date: 10 127 12021 (Application Submitted)
Signed:	Date:/
Applicant/Representative (if not property owner)	(Application Submitted)
	* ×
Accepted By:	Date:/
Director / Staff	

Irrigation Plan Map Requirements

The irrigation plan must be on a scalable map and show all of the irrigation system including all supply and drainage

structures and easements. Please include the following information on you map: 1 All canals, ditches, and laterals with their respective names. **2** Head gate location and/or point if delivery of water to the property by the irrigation entity. **3** Rise locations and types, if any. 4 Easements of all private ditches that supply adjacent properties (i.e. supply ditches and drainage ways). **5** Slope of the property in various locations. \bullet Direction of water flow (use short arrows → on your map to indicate water flow direction). 7 Direction of wastewater flow (use long arrows ------ \rightarrow on you map to indicate wastewater direction). **8** Location of drainage ponds or swales, anywhere wastewater will be retained on the property. 9X Other information: There is not an irrigation plan included. Please see memo from SPF Water Engineering included with this application Also, provide the following documentation: П Copy of any water users' association / agreement (s) that are currently in effect, which outlines water schedules and maintenance responsibilities.



MEMORANDUM

DATE: October 25, 2021

TO: Matt Drown – Ridgeline Vistas, LLC

FROM: Terry Scanlan, P.E., P.G.

SPF NO: 1712.0010

RE: Ridgeline Vistas Subdivision Water Supply Recommendations

Project Description. Ridgeline Vistas, LLC proposes to develop a 190.72-acre site in Sections 5 and 6, Township 5 North, Range 2 West, Canyon County. The site is proposed as a 20-lot residential subdivision to be known as Ridgeline Vistas Subdivision. Subtracting 11.32 acres for road right-of-way, the residential development area will be 179.40 acres. Lot sizes will range from 8.44 acres to 9.7 acres in size, with an average size of 9.0 acres. The lot distribution from the preliminary plat is shown below as Figure 1.

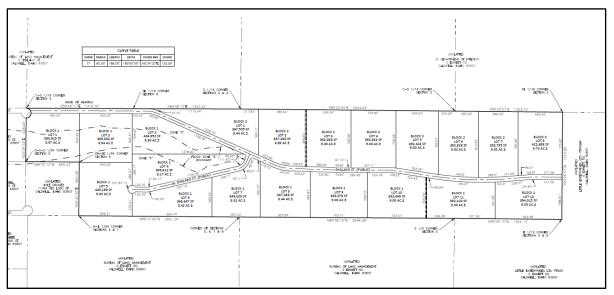


Figure 1. Ridgeline Vistas Subdivision lot distribution from preliminary plat (KM Engineering, 10/12/21)

Existing Water Rights. There are three water rights, two for irrigation and one for domestic and stockwater, associated with the property. Copies of existing water rights are provided as Attachment A.

• The two irrigation water rights, 63-32851 and 63-31214, authorize irrigation of 107 acres at a combined diversion rate of 2.14 cfs (960 gpm) from a groundwater well located within proposed Lot 8 of Block 1. These two water rights can be divided among the 20 lots as part of the development.

300 E. Mallard Drive, Suite 350, Boise, Idaho 83706

Matt Drown October 25, 2021

• The domestic and stockwater right, 63-18929, authorizes diversion of 0.11 cfs, not to exceed 13,000 gpd, from a well within proposed Lot 7 of Block 1. This water right should be assigned to Lot 7 Block 1.

Idaho Department of Water Resources records also lists four other irrigation water rights as appurtenant to the property. These water rights¹ were previously sold to others for mitigation or other purposes and are not available for use on the property.

Proposed Water Right Action. Ridgeline Vista, LLC proposes to divide irrigation water rights 63-32851 and 63-31214 into twenty separate water rights for each of the 20 lots. Water rights assigned to lots will vary, with flatter lots receiving larger allocations and steeper lots receiving smaller allocations. A proposed allocation is provided in the table below. Each water right acre is authorized 0.02 cfs (9 gpm).

Table 1. Proposed Irrigation Water Right Allocation

Dlock	Lot	١	Rate		
Block Lot		Total	63-31214	63-32851	(cfs)
1	1	7		7	0.14
1	2	7		7	0.14
1	3	7		7	0.14
1	4	8	1	7	0.16
1	5	7		7	0.14
1	6	7		7	0.14
1	7	5	5		0.10
1	8	6	6		0.12
1	9	8	8		0.16
1	10	8	8		0.16
1	11	8	8		0.16
1	12	8	8	0.16	
2	1	4	4		0.08
2	2	4	4		0.08
2	3	2	2		0.04
2	4	3	3		0.06
2	5	4	4		0.08
2	6	2	2		0.04
2	7	1	1		0.02
2	8	1	1		0.02
Tota	al	107	65	42	2.14

¹ 63-32852 (Flynn) for irrigation of 3 acres, 63-33313 (Peer) for irrigation of 2 acres, 63-33314 (Seel) for irrigation of 2.5 acres, and 63-33363 (Thacker) for irrigation of 1.0 acres.

Matt Drown October 25, 2021

The process for dividing the water rights will consist of submitting 19 applications for transfer of water right to the Idaho Department of Water Resources. Each application will create a new water right from the assigned portion, with a new point of diversion within that lot. Lot 8 Block 1 will not require a transfer application because it will retain the remaining 6 acres of water right 63-31214 and the authorized point of diversion. Upon approval of the transfer applications, each lot will have an appurtenant water right that shall be conveyed with sale of the lot.

Water rights for domestic purposes can be established without a water right action through domestic use provisions of Idaho Code 42-111 and 42-227. Each lot that constructs a well can utilize groundwater for domestic purpose, including stockwater and up to ½ acres of irrigation, provided that the use does not exceed 13,000 gallons per day. As noted previously, existing domestic and stockwater right 63-18929 can be conveyed with Lot 7 of Block 1. The purchase agreement or deed for Lot 7 should explicitly state that water right 63-18929 is included.

Proposed Water System. Domestic and irrigation water supplies to the subdivision will be supplied from either 1 or 2 wells located on each lot. A domestic well can be used for diversion of irrigation water under the water right allocation listed previously. Alternatively, a separate irrigation well can be constructed.

Static water levels are anticipated to average approximately 200 feet below ground surface, which will require well depths of 300 to 400 feet.

- For a two-well option, a lot could have separate domestic and irrigation wells. Under this alternative, a 6-inch well would be constructed for domestic purposes. The 6-inch well would have a target depth of approximately 350 feet and be equipped with a 4-inch diameter 3-hp or 5-hp pump rated to produce approximately 20 gpm for domestic purposes. An 8-inch well could be constructed to approximately 400 feet and (depending on diversion rate) be equipped with a 5 to 15 hp submersible pump, 6-inch diameter, for irrigation purposes. The horsepower will vary according to acres irrigated, with those lots irrigating 7 acres or more likely requiring a 10 or 15 hp pump.
- For a single-well option, an 8-inch well could be constructed to approximately 400 feet, and equipped with a 5 to 20-hp variable speed submersible pump for both domestic and irrigation purposes. As an alternative to a single large pump, a homeowner could consider a two-pump system, with a smaller domestic pump and a larger irrigation pump. The single-well option will be most cost effective.

Regardless of the option selected, high-capacity wells (i.e., those designed to produce more than approximately 30 gpm) should be drilled using open-hole mud-rotary or reverse-rotary methods with sand filter pack and stainless-steel or PVC well screen. Such construction will minimize sand pumping problems and generally result in more efficient wells. Small capacity wells, requiring less than 30 gpm, can be drilled using air-rotary methods but are likely to be less efficient.

Attachment A Water Right Reports and Maps

IDAHO DEPARTMENT OF WATER RESOURCES

WATER RIGHT REPORT

10/22/2021

IDAHO DEPARTMENT OF WATER RESOURCES

Water Right Report

WATER RIGHT NO. 63-31214

Owner Type Name and Address

Current Owner RIDGELINE VISTAS LLC

ATTN MATT DROWN 2150 W PACIFIC RIDGE

EAGLE, ID 83616

2088699760

Original Owner TRACY DOYLE

PO BOX 61

MIDDLETON, ID 83644

2089657932

Original Owner CHRISTOPHER E DOYLE

PO BOX 610

MIDDLETON, ID 83644

2085734952

Priority Date: 04/26/1971

Basis: Decreed Status: Active

Source <u>Tributary</u>

GROUND WATER

Beneficial Use
IRRIGATIONFrom
04/15To
10/15Diversion Rate
1.3 CFSVolume
266.76 AFATotal Diversion1.3 CFS266.76 AFA

Location of Point(s) of Diversion:

GROUND WATER SWSWSW Sec. 05 Township 05N Range 02W CANYON County

Place(s) of use:

Place of Use Legal Description: IRRIGATION CANYON County

<u>Township</u>	<u>Range</u>	<u>Section</u>	<u>Lot</u>	<u>Tract</u>	<u>Acres</u>									
05N	02W	5		SWSW	25		SESW	25						
				SWSE	15									

Total Acres: 65

Conditions of Approval:

- 1. S39 THE USE OF WATER FOR IRRIGATION UNDER THIS RIGHT MAY BEGIN AS EARLY AS MARCH 1 AND MAY CONTINUE TO AS LATE AS NOVEMBER 15, PROVIDED OTHER ELEMENTS OF THE RIGHT ARE NOT EXCEEDED. THE USE OF WATER BEFORE APRIL 15 AND AFTER OCTOBER 15 UNDER THIS REMARK IS SUBORDINATE TO ALL WATER RIGHTS HAVING NO SUBORDINATED EARLY OR LATE IRRIGATION USE AND A PRIORITY DATE EARLIER THAN THE DATE A PARTIAL DECREE IS ENTERED FOR THIS RIGHT.
- 2. C18 This partial decree is subject to such general provisions necessary for the definition of the rights or for the efficient administration of the water rights as may be ultimately determined by the Court at a point in time no later than the entry of a final unified decree. Section 42-1412(6), Idaho Code.
- 3. P21 THIS RIGHT IS A SPLIT FROM FORMER RIGHT 63-7421.
- 4. T07 The right holder shall accomplish the change authorized by Transfer 71086 within one (1) year of the date of this approval or 5/7/05.
- 5. To Failure of the right holder to comply with the conditions of Transfer No. 71086 is cause for the Director to rescind approval of the transfer.
- 6. 01M After specific notification by the Department, the right holder shall install a suitable measuring device or shall enter into an agreement with the Department to determine the amount of water diverted from power records and shall annually report the information to the Department.
- 7. R65 This right when combined with all other rights shall provide no more than 0.02 cfs per acre nor more than 4.5 afa per acre at the field headgate for irrigation of the lands above.
- 8. X36 Rights 63-31213, 63-31215 and 63-31216 are also diverted through the point of diversion described above.

Dates:

Licensed Date:

Decreed Date: 01/23/2009

Enlargement Use Priority Date:

Enlargement Statute Priority Date:

Water Supply Bank Enrollment Date Accepted:

Water Supply Bank Enrollment Date Removed:

Application Received Date:

Protest Deadline Date:

Number of Protests: 0

Other Information:

State or Federal: S

Owner Name Connector: And

Water District Number: TBD

Generic Max Rate per Acre: 0.02

Generic Max Volume per Acre: 4.5

Civil Case Number:

Old Case Number:

Decree Plantiff:

Decree Defendant:

Swan Falls Trust or Nontrust:

Swan Falls Dismissed:

DLE Act Number:

Cary Act Number:

Mitigation Plan: False


State of Idaho Department of Water Resources

Water Right

63-31214

IRRIGATION

The map depicts the place of use for the water use listed above and point(s) of diversion of this right as currently derived from interpretations of the paper records and is used solely for illustrative purposes. Discrepancies between the computer representation and the permanent document file will be resolved in favor of the actual water right documents in the water right file.

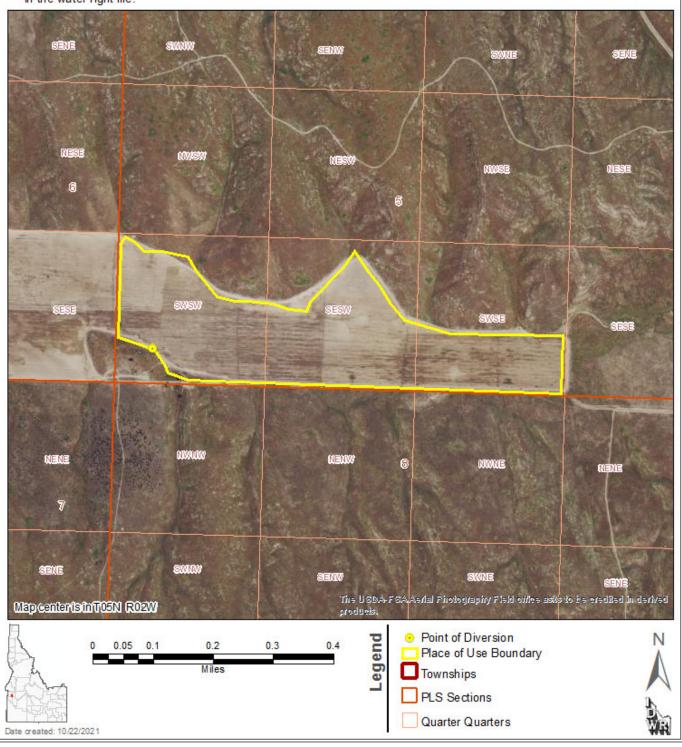

IDAHO DEPARTMENT OF WATER RESOURCES

WATER RIGHT REPORT

10/22/2021

IDAHO DEPARTMENT OF WATER RESOURCES

Water Right Report

WATER RIGHT NO. 63-32851

Owner Type Name and Address

Current Owner RIDGELINE VISTAS LLC

ATTN MATT DROWN 2150 W PACIFIC RIDGE

EAGLE, ID 83616

2088699760

Directors Report Owner HIGH PLAINS LLC

C/O FRANK FICKEN 2724 LAVENDER DR

WALNUT CREEK, CA 94596

9259630895

Original Owner C L SHAWVER

Original Owner D J SHAWVER

2710 ESQUIRE DR BOISE, ID 83704

2083752477

Priority Date: 04/26/1971

Basis: Decreed Status: Active

Source <u>Tributary</u>

GROUND WATER

Beneficial Use
IRRIGATIONFrom
04/15ToDiversion Rate
0.84 CFSVolumeTotal Diversion10/150.84 CFS172.4 AFA172.4 AFA

Location of Point(s) of Diversion:

Place(s) of use:

Place of Use Legal Description: IRRIGATION CANYON County

<u>Township</u>	<u>Range</u>	<u>Section</u>	<u>Lot</u>	<u>Tract</u>	<u>Acres</u>									
05N	02W	6		SWSE	28.2		SESE	13.8						

Total Acres: 42

Conditions of Approval:

- 1. Property also known as Lot 14, Blk. 1, High Plains Estates Subdivision.
- 2. 01M After specific notification by the Department, the right holder shall install a suitable measuring device or shall enter into an agreement with the Department to determine the amount of water diverted from power records and shall annually report the information to the Department.
- 3. This right is a split from former right 63-32131.
- 4. C18 This partial decree is subject to such general provisions necessary for the definition of the rights or for the efficient administration of the water rights as may be ultimately determined by the Court at a point in time no later than the entry of a final unified decree. Section 42-1412(6), Idaho Code.
- 5. S39 The use of water for irrigation under this right may begin as early as March 1 and may continue to as late as November 15, provided other elements of the right are not exceeded. The use of water before April 15 and after October 15 under this remark is subordinate to all water rights having no subordinated early or late irrigation use and a priority date earlier than the date a partial decree is entered for this right.

Dates:

Licensed Date:

Decreed Date: 02/02/2010

Enlargement Use Priority Date:

Enlargement Statute Priority Date:

Water Supply Bank Enrollment Date Accepted:

Water Supply Bank Enrollment Date Removed:

Application Received Date:

Protest Deadline Date:

Number of Protests: 0

Other Information:

State or Federal: S

Owner Name Connector:

Water District Number: TBD

Generic Max Rate per Acre: 0.02 Generic Max Volume per Acre: 4.5

Civil Case Number:
Old Case Number:
Decree Plantiff:
Decree Defendant:
Swan Falls Trust or Nontrust:
Swan Falls Dismissed:
DLE Act Number:
Cary Act Number:

Mitigation Plan: False


State of Idaho Department of Water Resources

Water Right

63-32851

IRRIGATION

The map depicts the place of use for the water use listed above and point(s) of diversion of this right as currently derived from interpretations of the paper records and is used solely for illustrative purposes. Discrepancies between the computer representation and the permanent document file will be resolved in favor of the actual water right documents in the water right file.

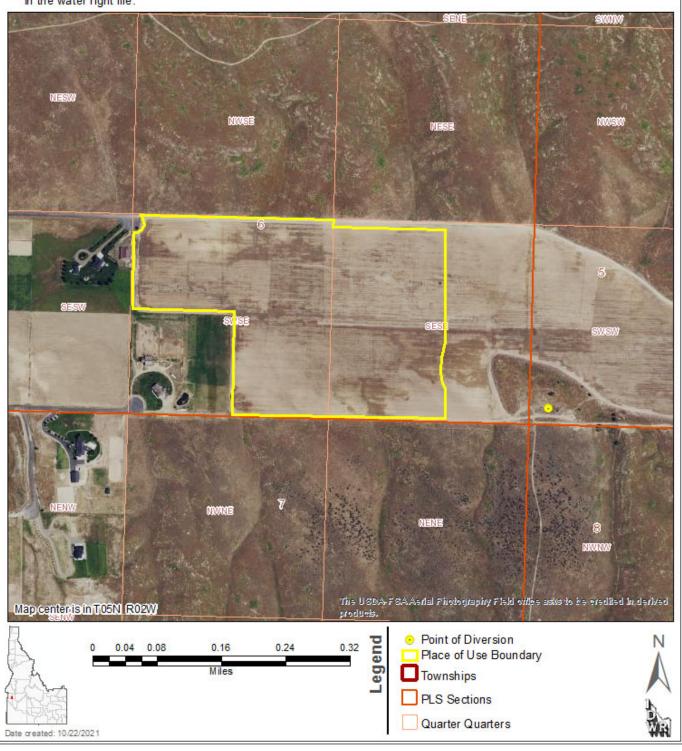

IDAHO DEPARTMENT OF WATER RESOURCES

WATER RIGHT REPORT

10/22/2021

IDAHO DEPARTMENT OF WATER RESOURCES

Water Right Report

WATER RIGHT NO. 63-18929

Owner Type Name and Address

Current Owner C L SHAWVER
Current Owner D J SHAWVER

2710 ESQUIRE DR BOISE, ID 83704 2083752477

Priority Date: 04/26/1971

Basis: Decreed Status: Active

Source <u>Tributary</u>

GROUND WATER

Beneficial Use
STOCKWATERFrom
1/01ToDiversion Rate
0.11 CFSVolumeDOMESTIC
Total Diversion1/01
12/3112/31
0.11 CFS0.11 CFS
0.11 CFS

Location of Point(s) of Diversion:

GROUND WATER SWSWSW Sec. 05 Township 05N Range 02W CANYON County

Place(s) of use:

Place of Use Legal Description: STOCKWATER CANYON County

<u>Township</u>	<u>Range</u>	<u>Section</u>	<u>Lot</u>	<u>Tract</u>	<u>Acres</u>									
05N	02W	5		SWSW										

Place of Use Legal Description: DOMESTIC CANYON County

<u>Township</u>	<u>Range</u>	<u>Section</u>	<u>Lot</u>	<u>Tract</u>	<u>Acres</u>									
05N	02W	5		swsw										

Conditions of Approval:

- 1. N13 THE QUANTITY OF WATER UNDER THIS RIGHT SHALL NOT EXCEED 13,000 GALLONS PER DAY.
- 2. N11 THE QUANTITY OF WATER DECREED FOR THIS WATER RIGHT IS NOT A DETERMINATION OF HISTORICAL BENEFICIAL USE.
- 3. C18 THIS PARTIAL DECREE IS SUBJECT TO SUCH GENERAL PROVISIONS NECESSARY FOR THE DEFINITION OF THE RIGHTS OR FOR THE EFFICIENT ADMINISTRATION OF THE WATER RIGHTS AS MAY BE ULTIMATELY DETERMINED BY THE COURT AT A POINT IN TIME NO LATER THAN ECREE. SECTION 42-1412(6), IDAHO CODE.
- PARCEL NO. 9R 05N02W056000

	THE ENTRY OF A FINAL UNIFIED DI						
4.	STOCKWATER, 450 RANGE CATTLE						
Date	s:						
Licensed Date:							
Decreed Date: 02/14/2000							
Enlargement Use Priority Date:							
Enlar	gement Statute Priority Date:						
Wate	er Supply Bank Enrollment Date Accepted:						
Wate	Water Supply Bank Enrollment Date Removed:						
Appl [.]	ication Received Date:						
Prote	Protest Deadline Date:						
Num	ber of Protests: 0						
Othe	r Information:						
State	e or Federal: S						
Own	Owner Name Connector: OR						
Water District Number: TBD							
Gene	Generic Max Rate per Acre:						
Generic Max Volume per Acre:							
Civil Case Number:							
Old Case Number:							
Decree Plantiff:							
Decree Defendant:							
Swan Falls Trust or Nontrust:							
Swan Falls Dismissed:							
DLE Act Number:							

Cary Act Number:

Mitigation Plan: False


State of Idaho Department of Water Resources

Water Right

63-18929


DOMESTIC

The map depicts the place of use for the water use listed above and point(s) of diversion of this right as currently derived from interpretations of the paper records and is used solely for illustrative purposes. Discrepancies between the computer representation and the permanent document file will be resolved in favor of the actual water right documents in the water right file.

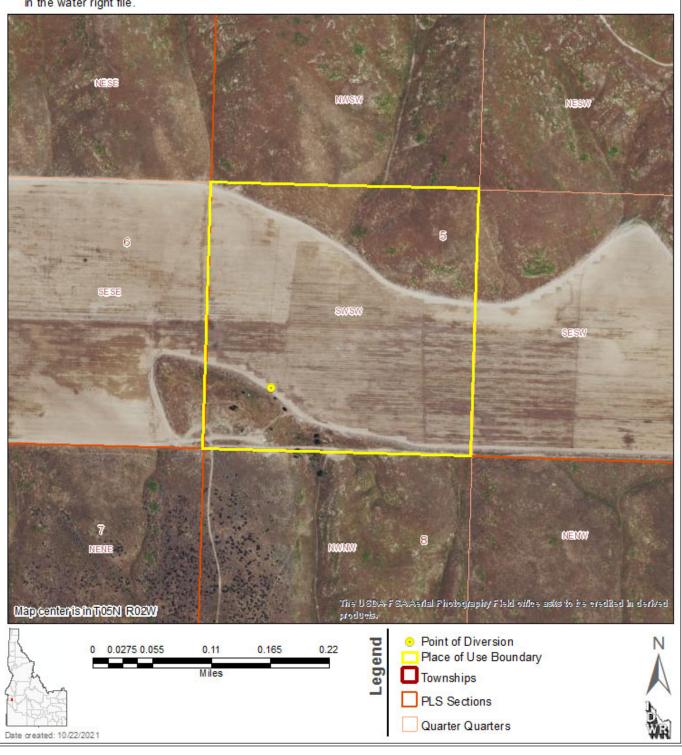


PRELIMINARY PLAT SHOWING RIDGELINE VISTAS SUBDIVISION

THE S 1/2 OF THE SW 1/4 AND THE SW 1/4 OF THE SE 1/4 OF SECTION 5, AND A PORTION OF THE S 1/2 OF THE SE 1/4 OF SECTION 6, TOWNSHIP 5 NORTH, RANGE 2 WEST, BOISE MERIDIAN, CANYON COUNTY, IDAHO 2021

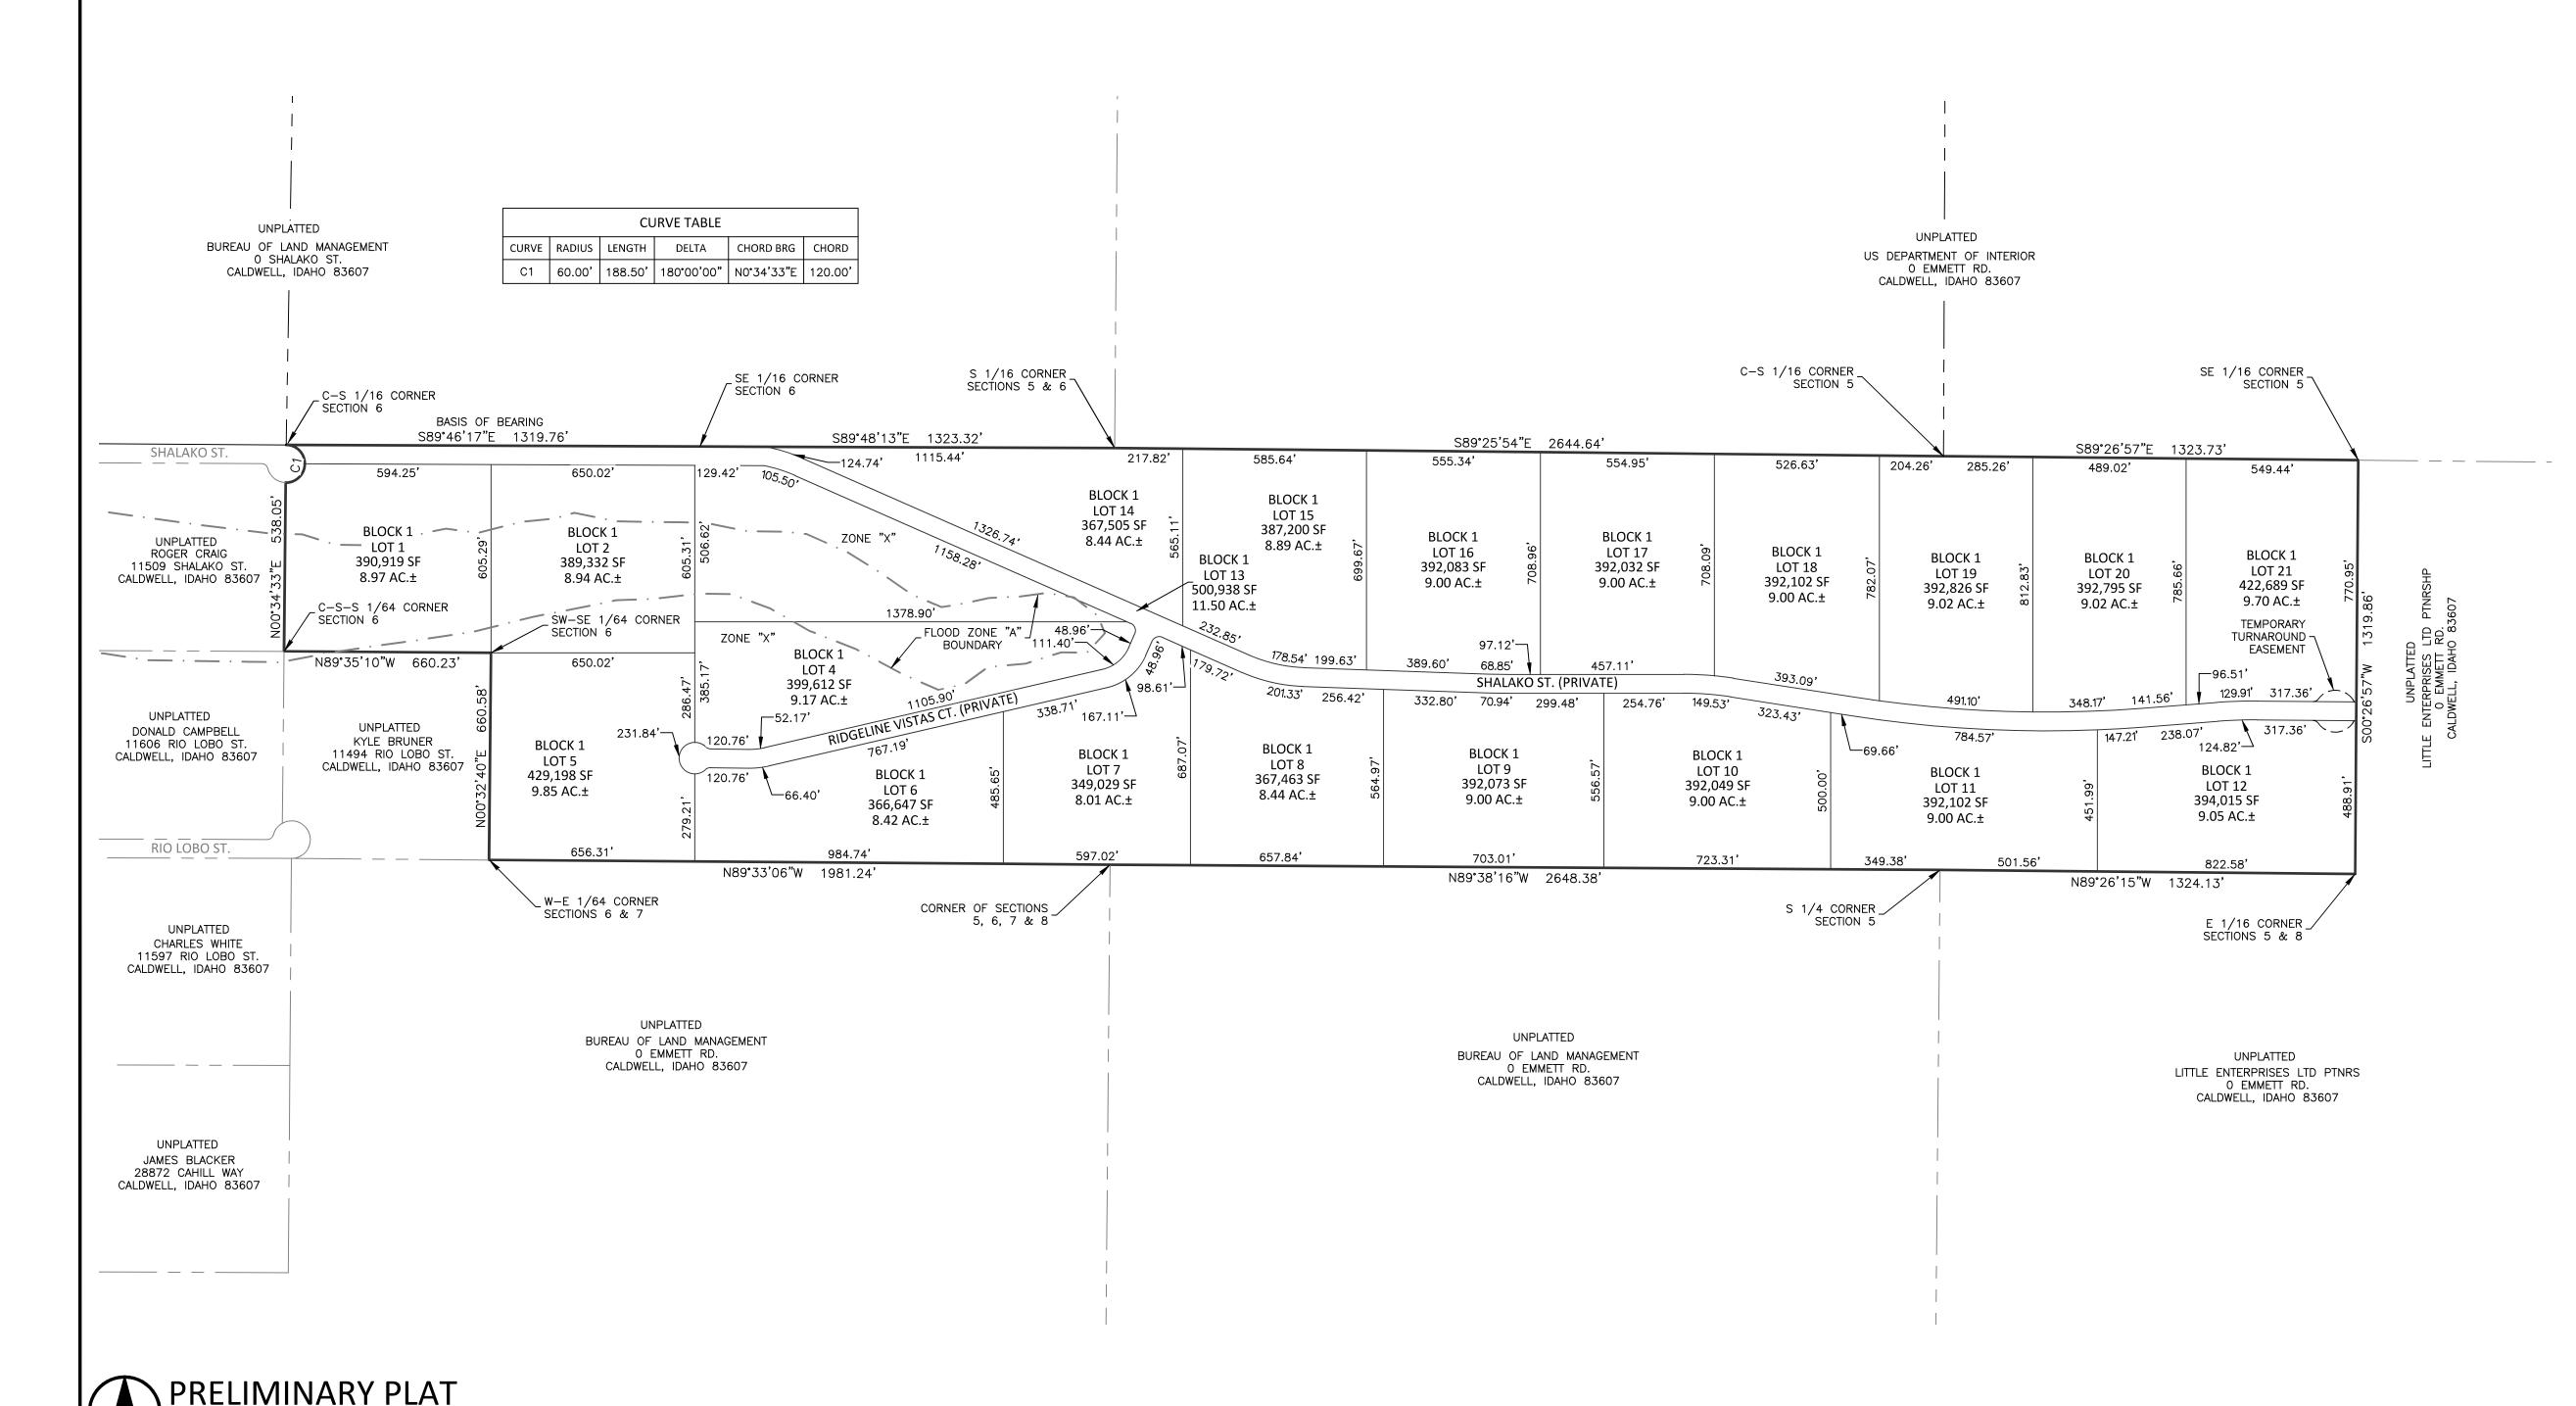

Plan Scale: 1" = 300'

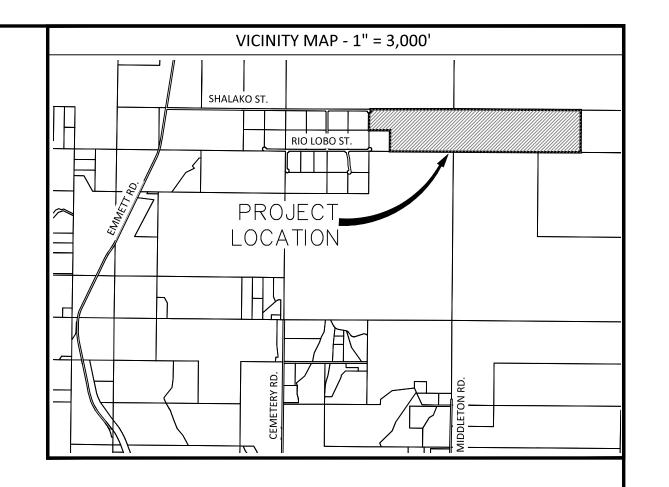

BOUNDARY LINE	BLOCK #	BLOCK NUMBER
OFFSITE PROPERTY LINE	(#)	LOT NUMBER
ROAD CENTERLINE	(R-R)	ZONING
SECTION LINE	(,	

GRAVEL BUILDING ENVELOPE

INDEX OF DRAWINGS

LEGEND

SHEET NO. SHEET TITLE SHEET PP1.0 PRELIMINARY PLAT SHEET PP2.0 EXISTING CONDITIONS

SHEETS PP3.0-PP3.3 PRELIMINARY ENGINEERING AND REVEGETATION PLAN

PRELIMINARY PLAT DATA

SITE DATA
CURRENT ZONING CR-R-R CONDITIONAL RURAL RESIDENTIAL

TOTAL AREA OF SITE 190.72 ACRES 190.72 ACRES AREA PROPOSED R-R

AREA COMMON LOT PRIVATE ROAD

OVERALL SINGLE FAMILY RESIDENTIAL LOT DATA (ZONE CR-R-R)

RESIDENTIAL LOTS 190.72 OVERALL ACREAGE RESIDENTIAL ACREAGE 179.22 0.11 RES./ACRE

349,029 SQ. FEET 8.01 ACRE 390,341 SQ. FEET 8.96 ACRES MINIMUM RESIDENTIAL LOT SIZE AVERAGE RESIDENTIAL LOT SIZE

EASEMENT DATA GENERAL UTILITY EASEMENT

FRONT AND REAR 10 FEET AS SHOWN HEREON

TEMPORARY TURNAROUND EASEMENT AS SHOWN HEREON

FRONT AND REAR

20 FEET 10 FEET CORNER 20 FEET

PRELIMINARY PLAT NOTES

- 1. THIS PROPERTY IS SUBJECT TO DEVELOPMENT AGREEMENT NO. 033 PER INSTRUMENT NUMBER 2021-034824.
- 2. THE HOMEOWNER'S ASSOCIATION, UNDERLYING PROPERTY OWNER OR ADJACENT PROPERTY OWNER IS RESPONSIBLE FOR ALL STORM DRAINAGE FACILITIES OUTSIDE THE PUBLIC RIGHT-OF-WAY, INCLUDING ALL ROUTINE AND HEAVY MAINTENANCE.
- 3. AS SHOWN HEREON, A PORTION OF THIS PLAT IS LOCATED WITHIN ZONE A, PER FLOOD INSURANCE RATE MAP, PANEL 150 OF 575, MAP NUMBER 16027C0150F, DATED MAY 24,
- 4. LOT 13, BLOCK 1 IS A COMMON LOT FOR THE PURPOSE OF A PRIVATE ROAD THAT SHALL BE OWNED AND MAINTAINED BY THE HOMEOWNER'S ASSOCIATION OR ASSIGNS.

SURVEY CONTROL NOTES

1. ALL SURVEY DATA IS BASED ON THE NAD83 STATE PLANE COORDINATE SYSTEM (IDAHO WEST 1103) AND VERTICAL (NAVD88) DATUM.

PRELIMINARY - NOT FOR CONSTRUCTION RIDGELINE VISTAS SUBDIVISION PRELIMINARY PLAT

CANYON COUNTY	/, IDAHO	
REVISIONS		
ITEM	DATE	
		ENGINEERING
		5725 NORTH DISCOVERY WAY BOISE, IDAHO 83713
		PHONE (208) 639-6939

PROJECT:


10/27/27

18-168

OWNER/DEVELOPER RIDGELINE VISTAS, LLC PHONE: (208) 867-5309 2150 W. PACIFIC RIDGE EAGLE, ID 83616

ENGINEERING CONSULTANT KM ENGINEERING, LLP 5725 N DISCOVERY WAY BOISE, IDAHO 83713 PHONE: (208) 639-6939 FAX: (208) 639-6930 CONTACT: KEVIN MCCARTHY, P.E.

EMAIL: kevin@kmengllp.com

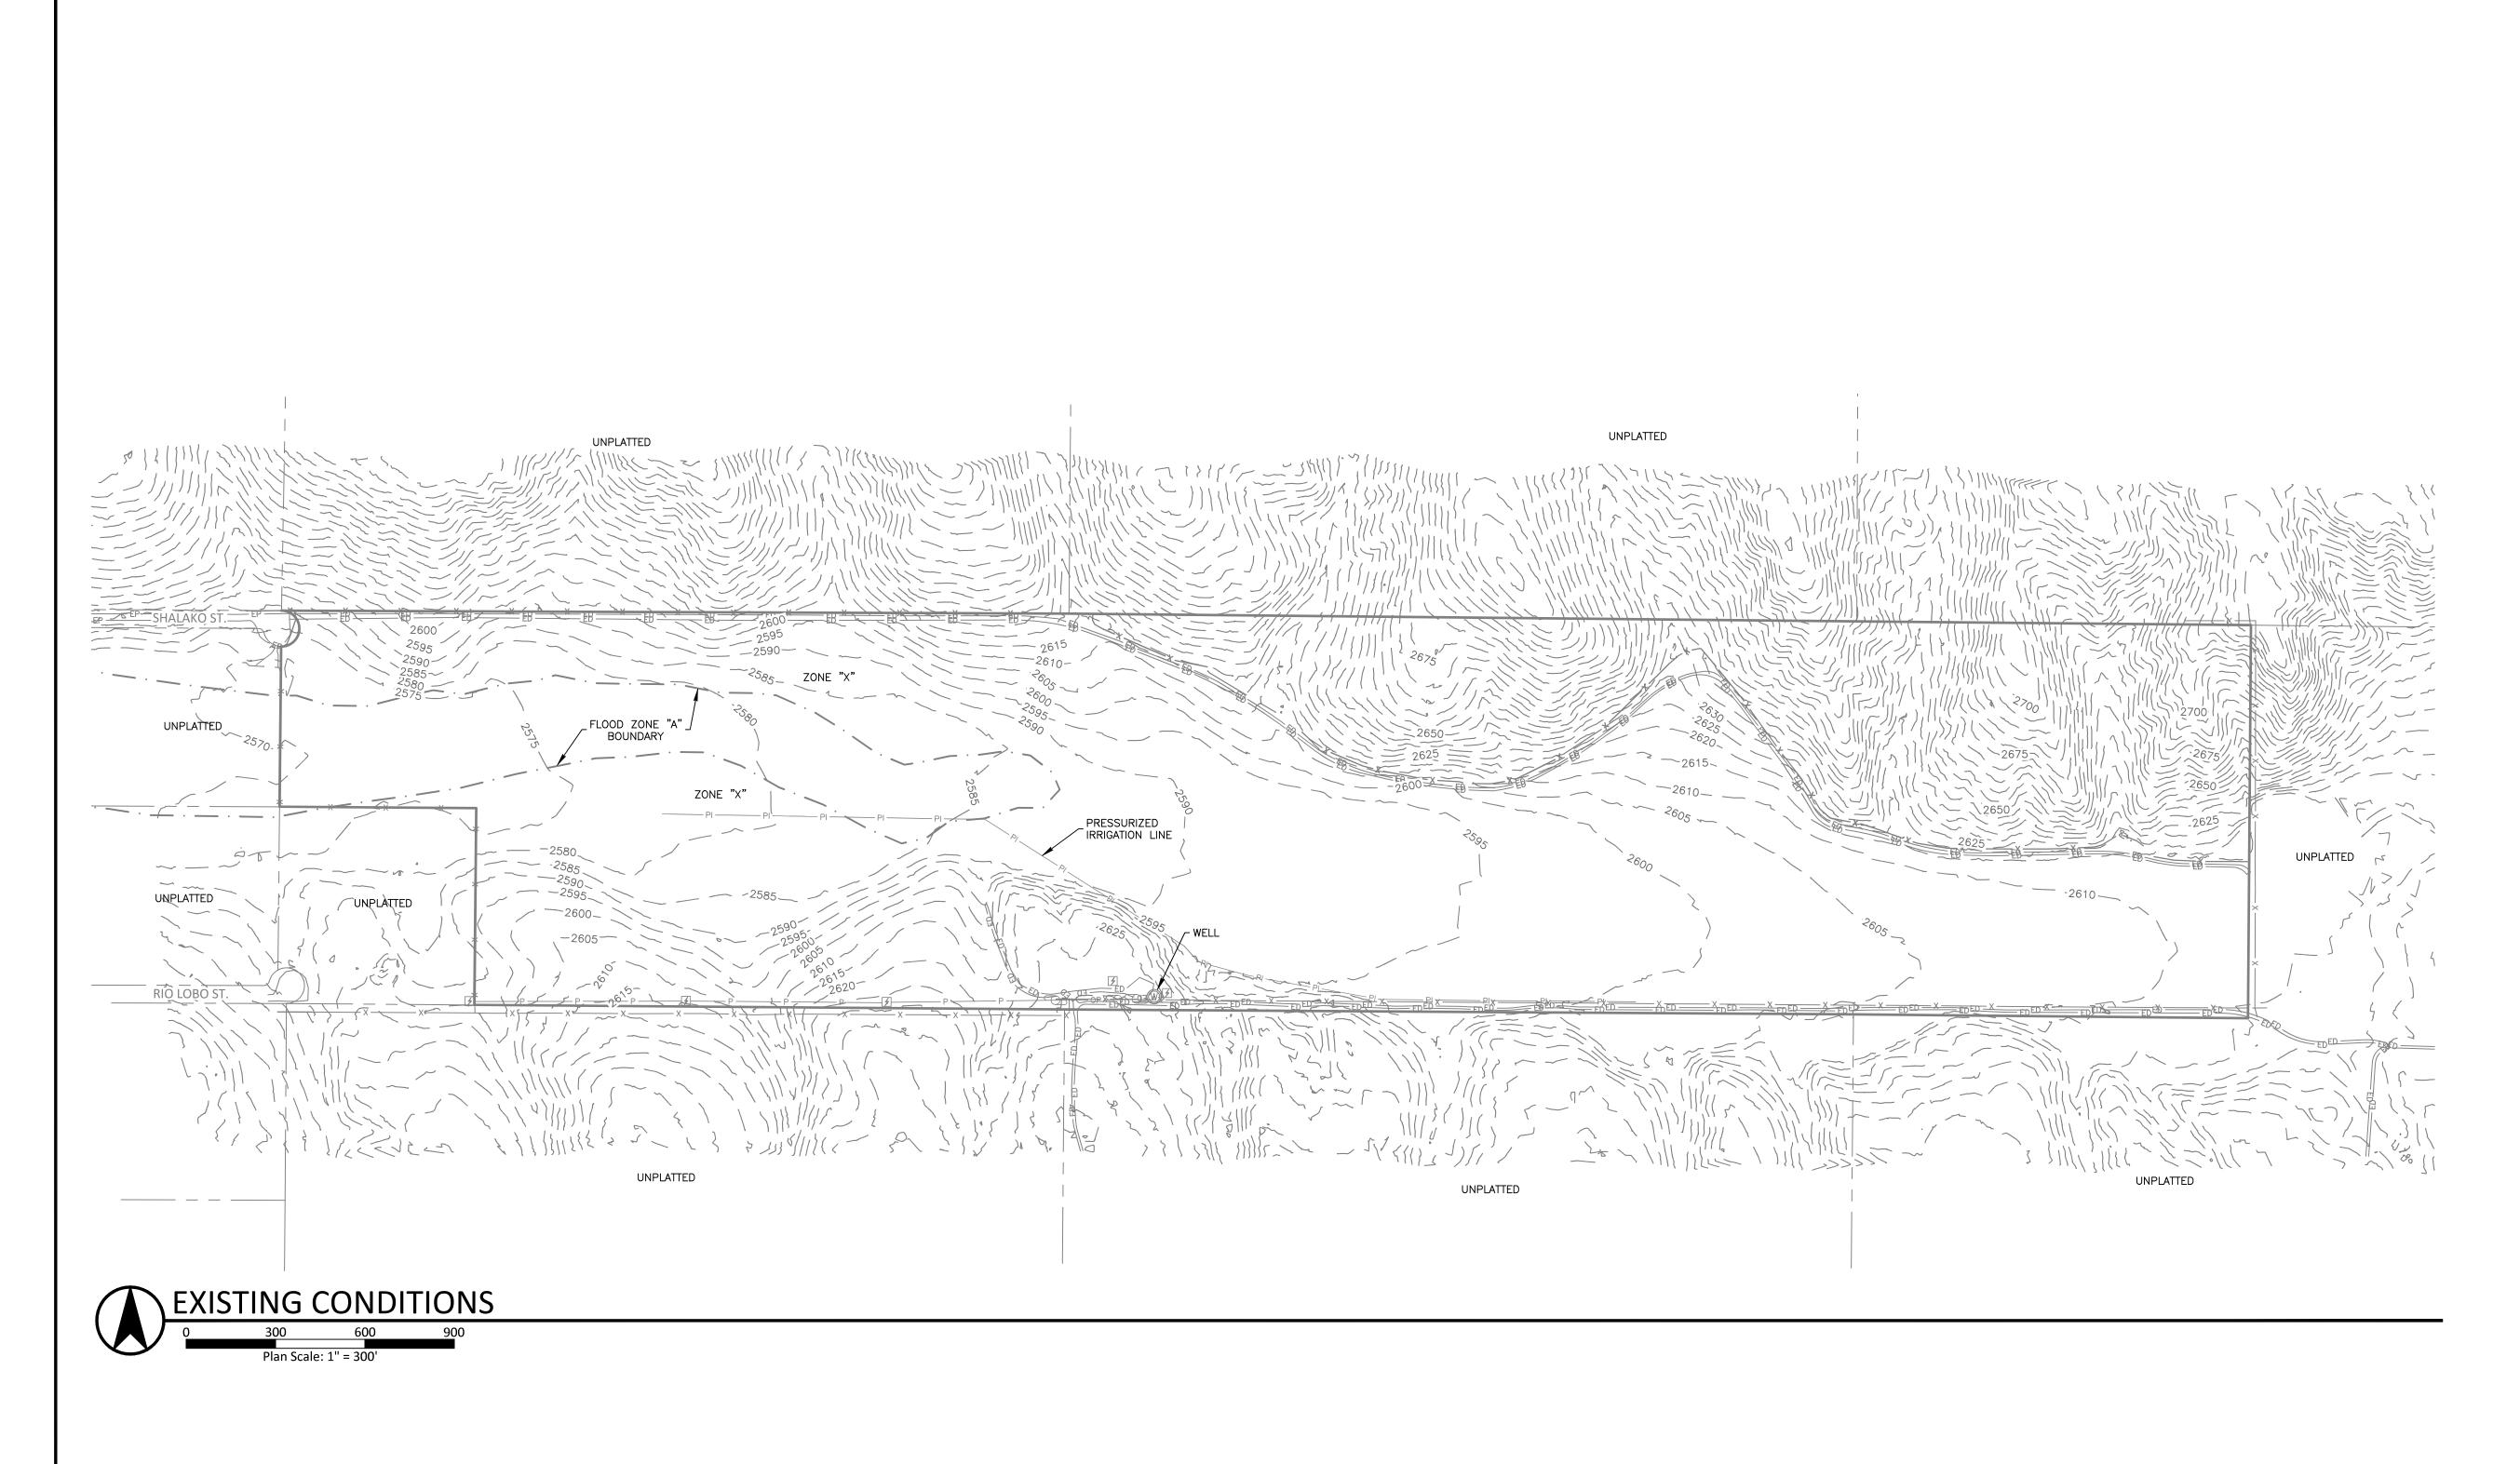

LEGEND

EXISTING IMPROVEMENTS

OP OP OP OP OVERHEAD POWER LINE

PP P P UNDERGROUND POWER LINE

PRESSURIZED IRRIGATION LINE

POWER/UTILITY POLE

ELECTRIC BOX/TRANSFORMER

WELL

EP EP EP ED EDGE OF PAVEMENT

EDGE OF DIRT ROAD

X X X X FENCE LINE

ASPHALT

SURVEY NOTES

- 1. THIS SURVEY WAS CONDUCTED IN THE SUMMER OF 2021.
- 2. UNDERGROUND UTILITIES SHOWN HEREON ARE APPROXIMATE LOCATION ONLY AND ARE BASED ON ABOVE GROUND EVIDENCE AND UTILITY MAPS OBTAINED FROM APPROPRIATE UTILITY COMPANIES.
- 3. THE VERTICAL DATUM USED HEREON IS BASED ON NAVD 88.

PRELIMINARY - NOT FOR CONSTRUCTION


RIDGELINE VISTAS SUBDIVISION EXISTING CONDITIONS CANYON COUNTY, IDAHO

REVISIONS

DATE

ENGINEERING


5725 NORTH DISCOVERY WAY
BOISE, IDAHO 83713
PHONE (208) 639-6939
kmengllp.com

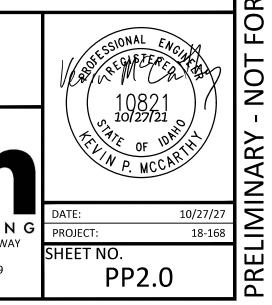

└ 3.0" ASPHALT PAVEMENT \ 6" OF 3/4"-MINUS CRUSHED AGGREGATE BASE 12" OF PIT RUN OVER COMPACTED

TYPICAL TWO LANE PRIVATE ROAD SECTION

1. STREET SECTION THICKNESS MAY BE REVISED DURING FINAL DESIGN.

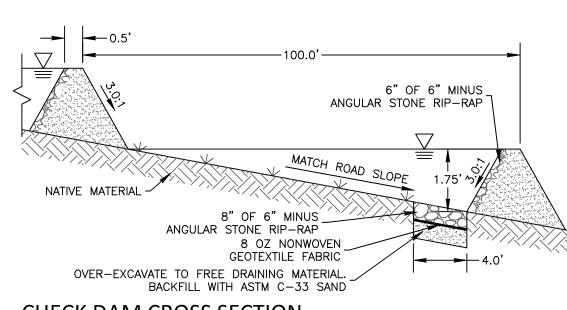

CHECK DAM CROSS SECTION

- 1. CHECK DAMS TO BE CONSTRUCTED OF CLAY SOIL TO MINIMIZE SEEPAGE OR ANGULAR ROCKS FOR CONVEYANCE SWALES.
- 2. SIDE SLOPES AND CHECK DAMS SHALL COMPLY WITH AASHTO CLEAR ZONE GUIDELINES

- 10. FINISH GRADES AT SUBDIVISION BOUNDARIES SHALL MATCH EXISTING GRADES.
- 11. BORROW DITCHES WILL BE PROTECTED VIA THE USE OF STRAW WADDLES AND CHECK DAMS. IF DAMAGE OCCURS DURING CONSTRUCTION, THE CONTRACTOR SHALL REPAIR THESE FACILITIES AS NEEDED.

GENERAL NOTES

FIELD VERIFICATION OF QUANTITIES SHALL BE THE RESPONSIBILITY OF THE CONTRACTOR. DISTURBED AREAS ON

GRADING LEGEND

---- GRADE BREAK

2900 _____ FINISHED GRADE CONTOUR

PROVIDE SOIL TEXTURE IMPROVEMENT. OR REMOVED AND DISPOSED OF. NATURAL TOPSOIL OCCURS AT VARYING DEPTHS ON THE PROJECT SITE. THE TOPSOIL SHALL BE EXCAVATED AND STOCKPILED AT DESIGNATED STORAGE AREAS PRIOR TO THE PROPOSED GRADING OPERATION, SAMPLES OF STOCKPILED SOIL SHALL BE TAKEN AND TESTED FOR SPECIFIC SOIL STRUCTURES AND FERTILITY. TEST RESULTS WILL BE THE BASIS FOR DETERMINING WHICH, IF ANY, SOIL AMENDMENTS WILL BE NECESSARY TO PROMOTE PLANT ESTABLISHMENT AND GROWTH.

FORBS, AND INTRODUCED WEEDS.

REVEGETATION NOTES

<u>EXISTING TOPOGRAPHY & VEGETATION</u> THE AREA TO BE REVEGETATED, AS OUTLINED ON THE PLAN

WITH THE BOISE AREA. THE SLOPES TO BE AFFECTED VARY IN DEGREE AND ASPECT. THE EXISTING VEGETATION CONSISTS PRIMARILY OF NATIVE DRYLAND SHRUBS, GRASSES, AND

CONSISTS OF FOOTHILL SLOPES AND RAVINES ASSOCIATED

<u>SITE PREPARATION/ TOPSOIL REMOVAL</u>
THE EARTHWORK PROCESS SHALL BEGIN WITH CLEARING

MINIMAL LARGE SHRUBS FROM THE AREAS TO BE DISTURBED WOODY STEMS AND BRANCHES WILL BE CHIPPED ON SITE 1

TOPSOIL DISTRIBUTION
ONCE THE GENERAL EARTHWORK IS COMPLETE AND FINE GRADING HAS BEEN ACCOMPLISHED, THE TOPSOIL SHALL BI REDISTRIBUTED OVER AREAS TO A MINIMUM DEPTH OF FOUR (4) INCHES. WHERE NEEDED, SLOPES SHALL BE GRADED WITH SERRATION TO HOLD THE TOPSOIL ADEQUATELY. THE TOPSOIL SHALL BE SPREAD AND LIGHTLY COMPACTED UTILIZING A BULLDOZER TRACTOR OR OTHER METHOD WITH EQUAL CAPABILITY. IT IS OUR RECOMMENDATION THAT ANY NECESSARY MECHANICAL MEANS OF EROSION CONTROL BE ACCOMPLISHED AS GRADING IS COMPLETED.

REVEGETATION SEEDING SHALL FOLLOW IMMEDIATELY AFTER TOPSOIL PLACEMENT AND FINE GRADING IN ORDER TO ELIMINATE SURFACE CRUSTING AND TO FACILITATE BETTER ROOT PENETRATION, THE SURFACE SHALL BE SCARIFIED OR AGAIN "CAT TRACKED" PRIOR TO SEEDING.

SEEDING

DRILL SEEDING TO SLOPES LESS THAN 4:1 AND BROADCAST SEEDING BY HYDROSEEDER FOR GREATER SLOPES SHALL BE USED TO APPLY THE SEED TO THE PROJECT SITE. THE SEED MIX OR MIXES SHALL BE DEFINED ON THE FINAL CONSTRUCTION PLANS.

HE SEEDING WILL RELY UPON NATURAL PRECIPITATION FOR SEED GERMINATION AND ESTABLISHMENT. MINIMUM GERMINATION OF 90 PERCENT IS REQUIRED. CONTRACTOR SHALL RESEED OR OVERSEED AS NECESSARY TO MEET THIS GERMINATION. TEMPORARY IRRIGATION WILL BE NECESSARY IF THIS GERMINATION IS NOT MET OR IF SEED IS NOT INSTALLED WITHIN NON-IRRIGATED NATIVE SEED RECOMMENDED WINDOW.

NON IRRIGATED NATIVE SEED RECOMMENDED WINDOW: SPRING SEEDING - AFTER FROST LEAVES GROUND AND

TEMPERATURES ARE CONSISTENT ±FEB. 15-MAY 15

> FALL SEEDING - AFTER FIRST FROST IN FALL. ±OCTOBER 15- NOVEMBER 15 DO NOT APPLY SEED ON TOP OF

AMENDMENTS AND FERTILIZERS WILL BE ADDED TO THE TOPSOIL AS DETERMINED FROM THE SOIL TESTS, AND ONLY AS NECESSARY.

TO PROVIDE PROTECTIVE SEED COVER, AID IN EROSION

CONTROL AND HELP TO RETAIN MOISTURE, A GRASS-FIBER MULCH AND SYNTHETIC TACKIFIER SHALL BE BROADCAST IN A HYDROMULCH PROCESS FOLLOWING SEEDING. THE GRASS-FIBER MULCH IS BROADCAST AT A MINIMUM RATE OF TWO THOUSAND (1,000) POUNDS PER ACRE.

JNDER NORMAL CIRCUMSTANCES AND ADHERENCE TO THE CONSTRUCTION PRACTICES DESCRIBED IN THE REPORT, THE ABOVE RECOMMENDED EROSION CONTROL MEASURES WILL PROVIDE A STABLE SLOPE CONDITION. TO AVOID INCIDENTA EROSION IT IS IMPERATIVE THAT THE SLOPES, ONCE PREPARED, REMAIN UNDISTURBED UNTIL SEEDING COMMENCES.

A 90% VEGETATIVE COVER IS RECOMMENDED TO CONTROL EROSION. IF AN UNUSUAL SEASON OCCURS WITH EXCESSIV RAINFALL AND RUN-OFF, THE FOLLOWING MEASURES SHALL BE TAKEN. SURFACE CONDITIONS SHALL BE MONITORED ON A DAILY BASIS. IF EROSION DETRIMENTAL TO THE SLOPE IS OBSERVED OR ANTICIPATED DUE TO EXCESSIVE RAINFALL, ONE OR MORE REMEDIAL MEASURES SHALL BE IMPLEMENTED AS RECOMMENDED BY THE PROJECT GEOTECHNICAL ENGINEER. SURFACE RUNOFF SHALL BE CONTROLLED WITH INTERCEPTOR DITCHES CONSTRUCTED AT THE TOP OF SLOPI AND AT DOWN SLOPE INTERVALS AS REQUIRED. TRENCHING SHALL OCCUR AT SHALLOW ANGLES TO THE CONTOURS TO MINIMIZE FLOW VELOCITY. UNDER SEVERE RUNOFF CONDITIONS DITCHES MAY REQUIRE EROSION CONTROL MEASURES TO COLLECT SEDIMENT AND PREVENT DITCH EROSION. ROCK CHECK DAMS SHALL BE USED TO CONTRO SWALE EROSION. SHOULD ERODED SEDIMENTS THREATEN ADJACENT PROPERTIES OR DRAINAGE SYSTEMS, THE TOE OF


THE SLOPE SHALL BE LINED WITH BALES OR SILT FENCES

TO CONTAIN SEDIMENTS ON-SITE.

GENERAL NOTES
FIELD VERIFICATION OF QUANTITIES SHALL BE THE
RESPONSIBILITY OF THE CONTRACTOR. DISTURBED AREAS ON REVEGETATION PLAN ARE SCHEMATIC.

REVEGETATION SUMMARY

AREA TO BE HYDROSEEDED 302,828 SF ± (6.95 AC ±)

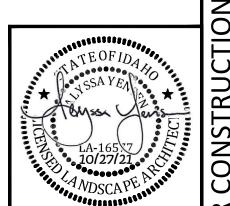

PRELIMINARY - NOT FOR CONSTRUCTION RIDGELINE VISTAS SUBDIVISION PRELIMINARY ENGINEERING AND REVEGETATION PLAN


CANYON COUNTY, IDAHO REVISIONS DATE

5725 NORTH DISCOVERY WAY BOISE, IDAHO 83713 PHONE (208) 639-6939


kmengllp.com

10/27/27

18-168

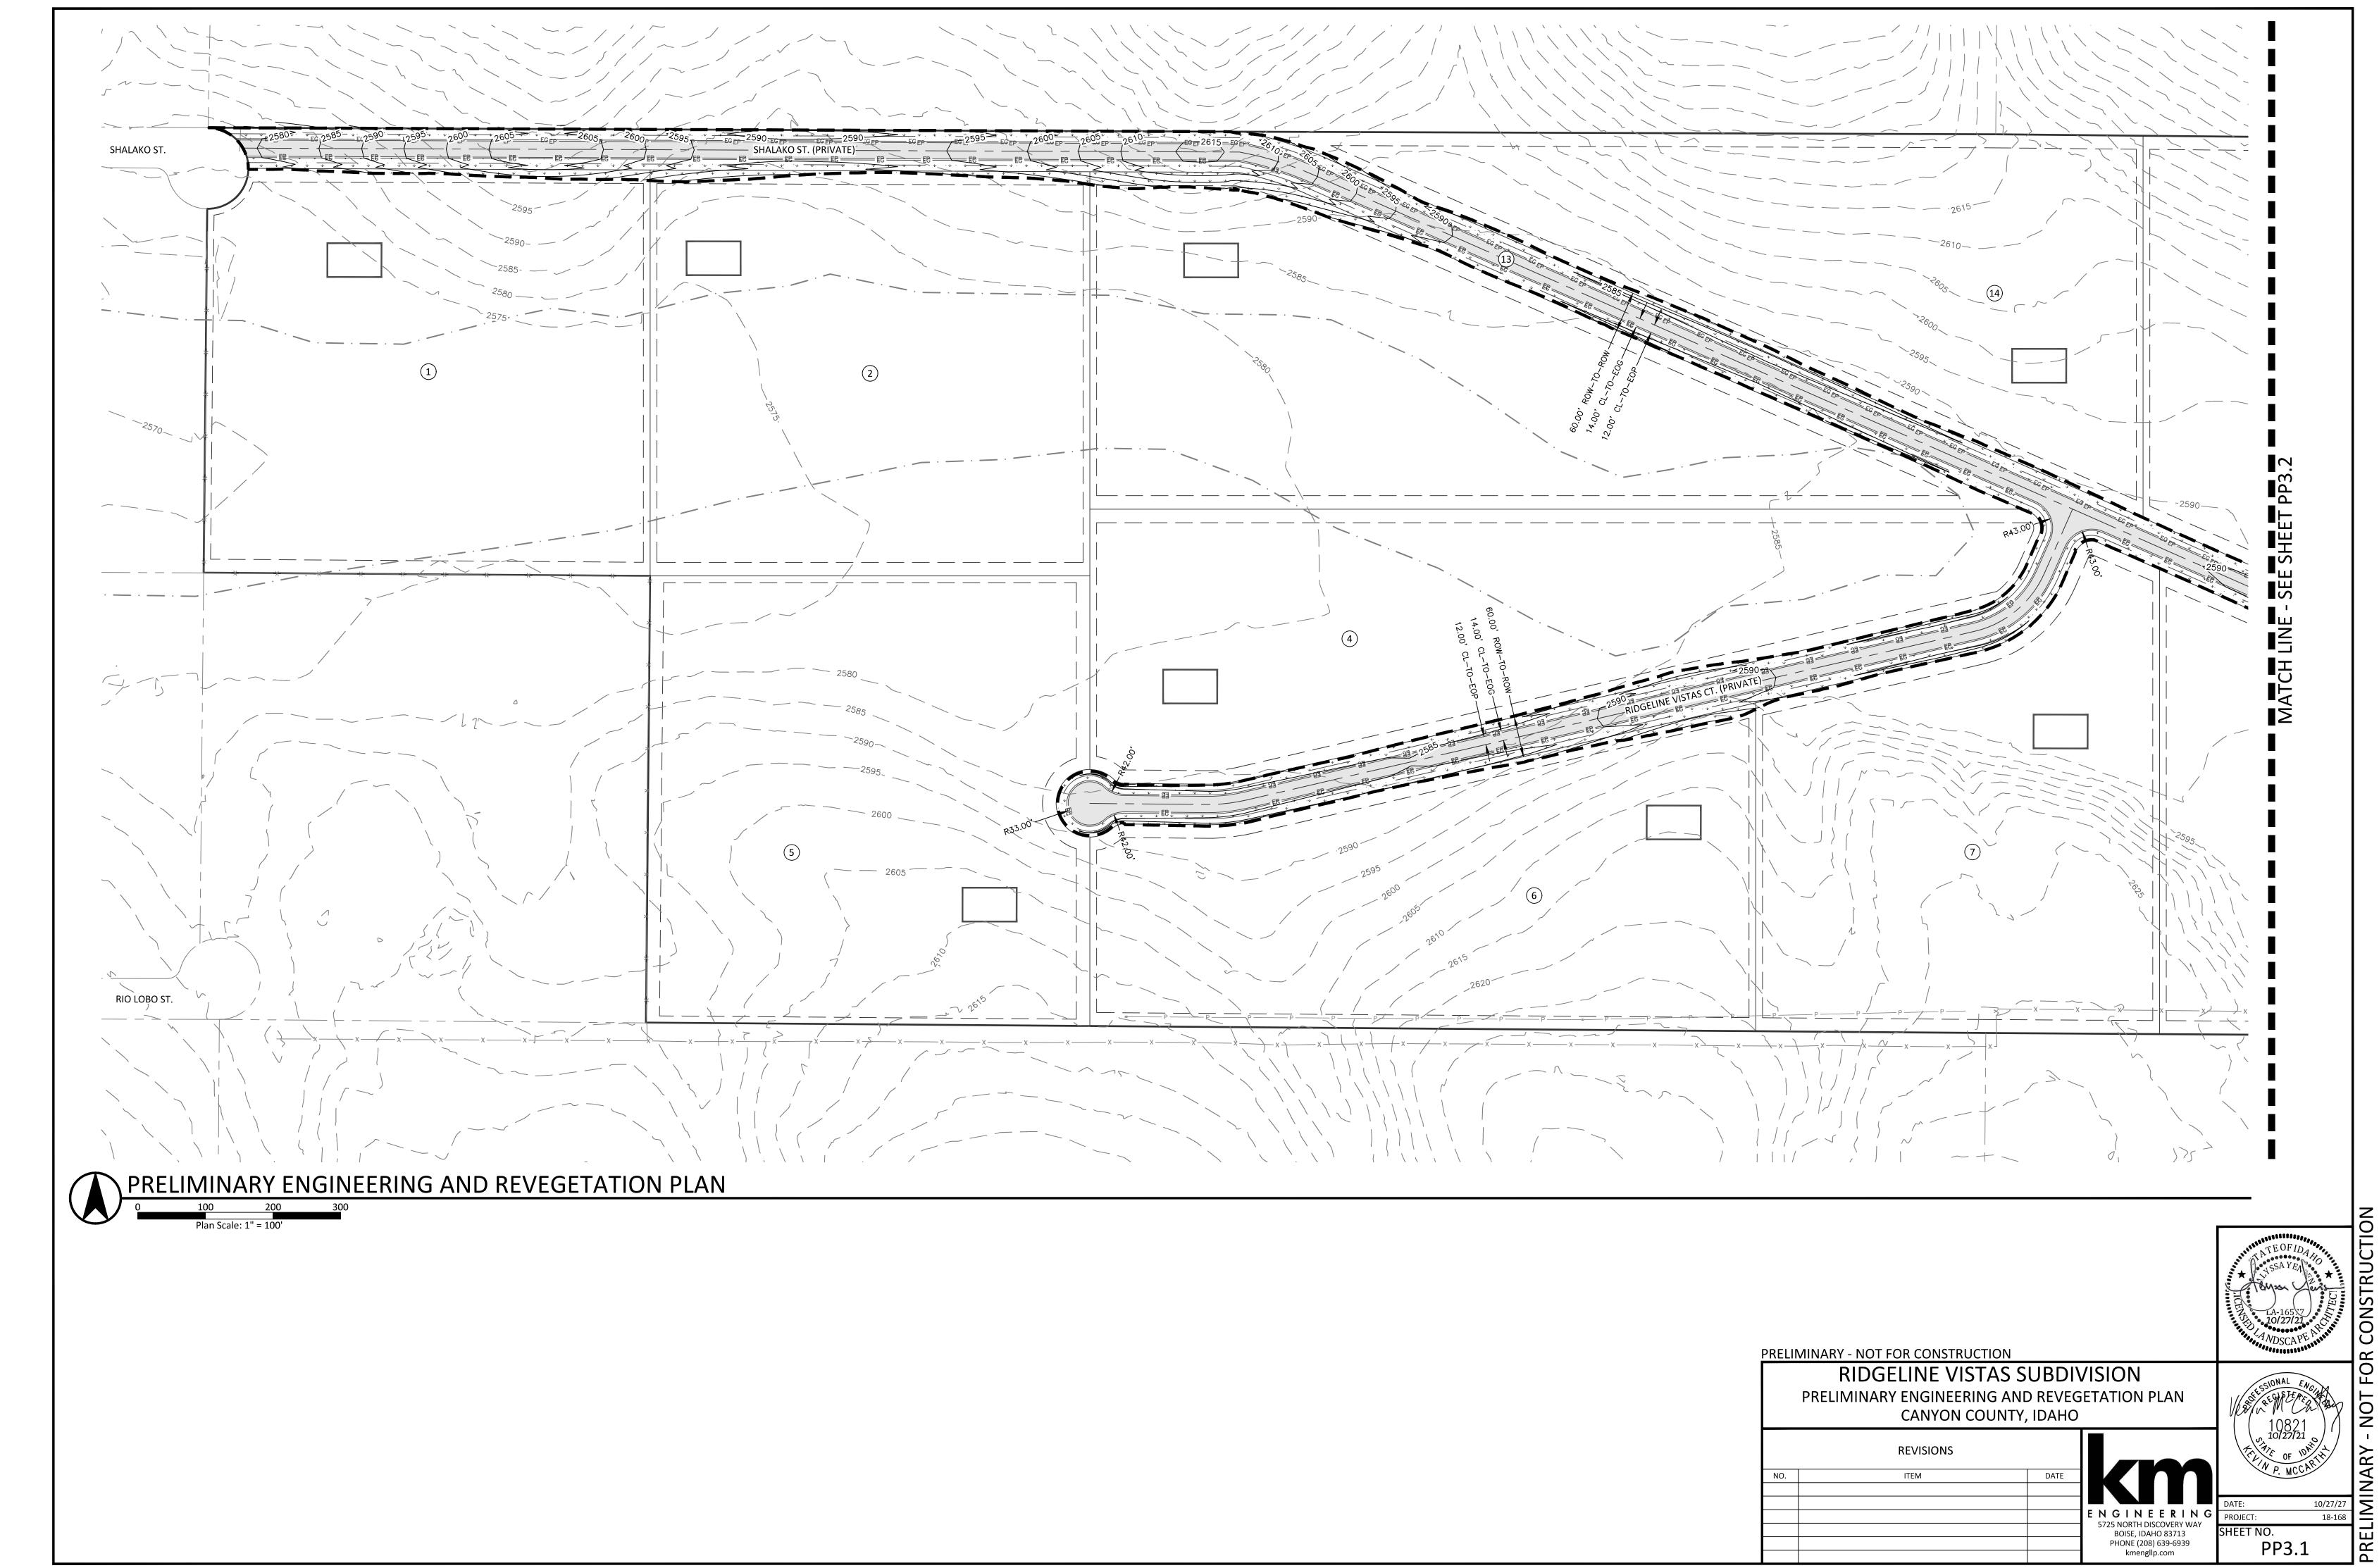

PP3.1

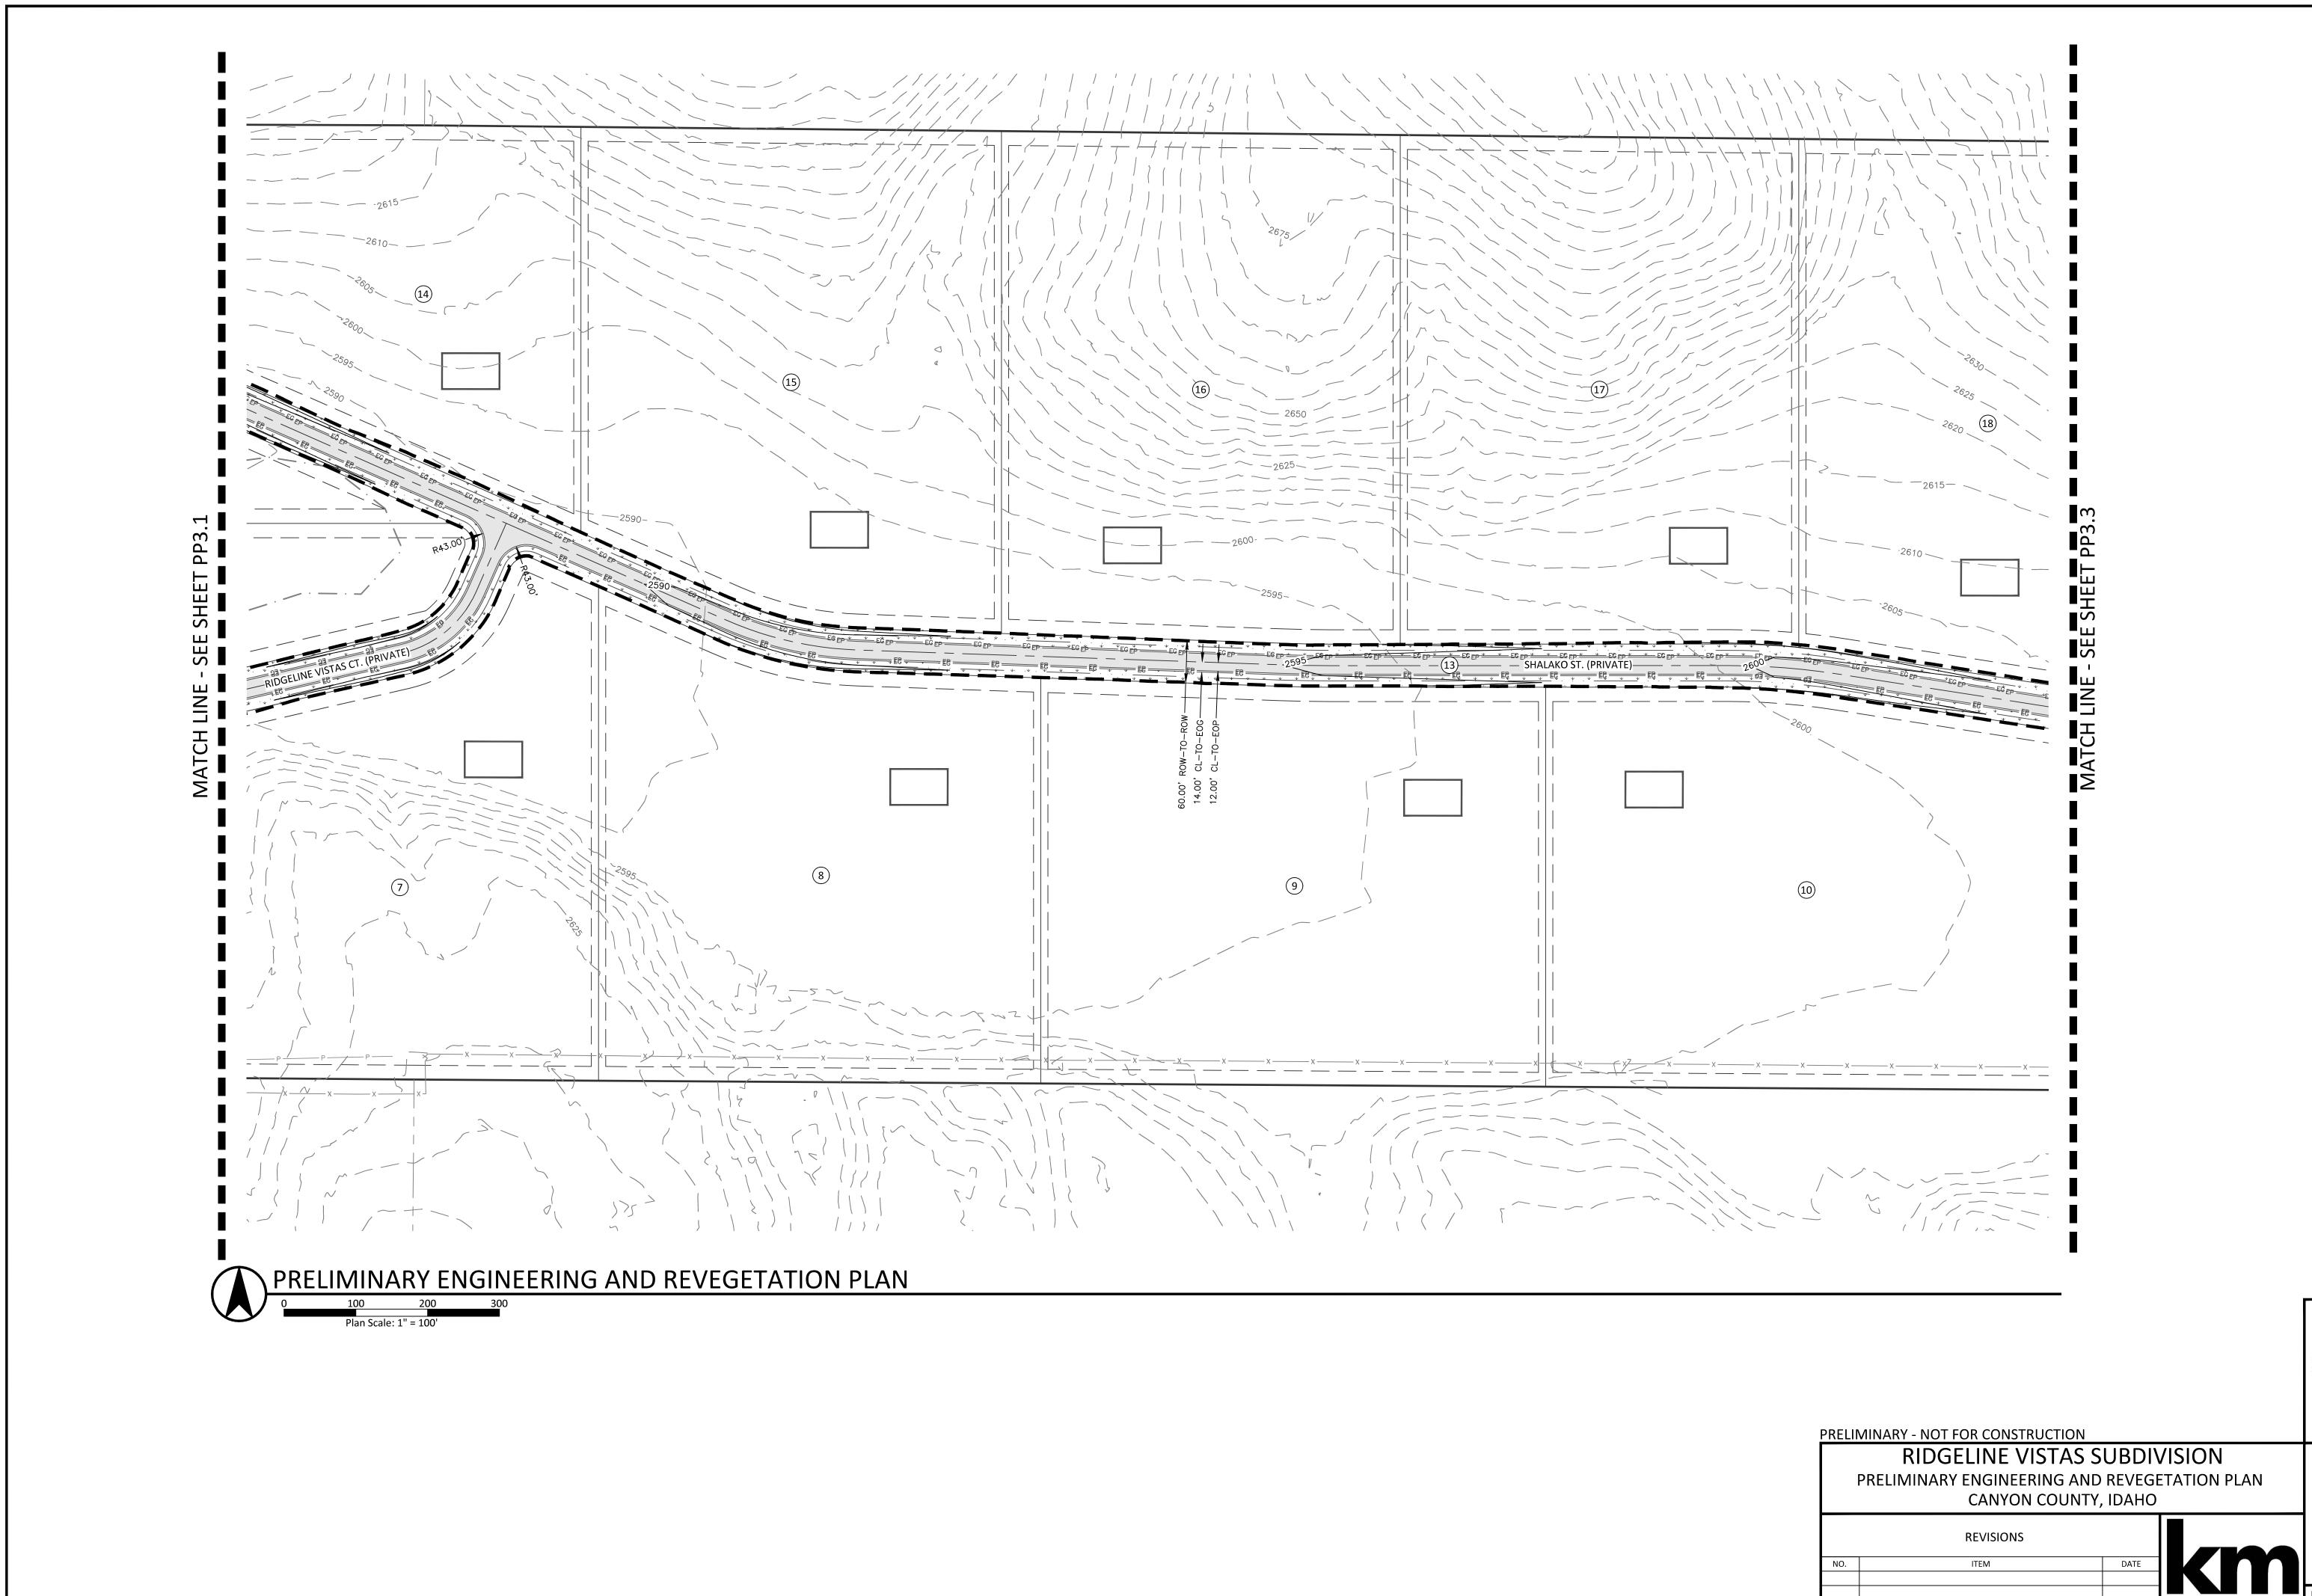

ARY - NOT FOR CONSTRUCTION

10821 10127121 10 P. MCCAR

ENGINEERING
5725 NORTH DISCOVERY WAY
BOISE, IDAHO 83713
PHONE (208) 639-6939
kmengllp.com

DATE: 10/27/27
PROJECT: 18-168

SHEET NO.
PP3.2




PRELIMINARY ENGINEERING AND REVEGETATION PLAN


CANYON COUNTY,	IDAHO	
REVISIONS		
ITEM	DATE	
		ENGINEERING
		5725 NORTH DISCOVERY WAY BOISE, IDAHO 83713
		PHONE (208) 639-6939
		kmengllp.com

PP3.3

PRELIMINARY PLAT SHOWING RIDGELINE VISTAS SUBDIVISION

THE S 1/2 OF THE SW 1/4 AND THE SW 1/4 OF THE SE 1/4 OF SECTION 5, AND A PORTION OF THE S 1/2 OF THE SE 1/4 OF SECTION 6, TOWNSHIP 5 NORTH, RANGE 2 WEST, BOISE MERIDIAN, CANYON COUNTY, IDAHO

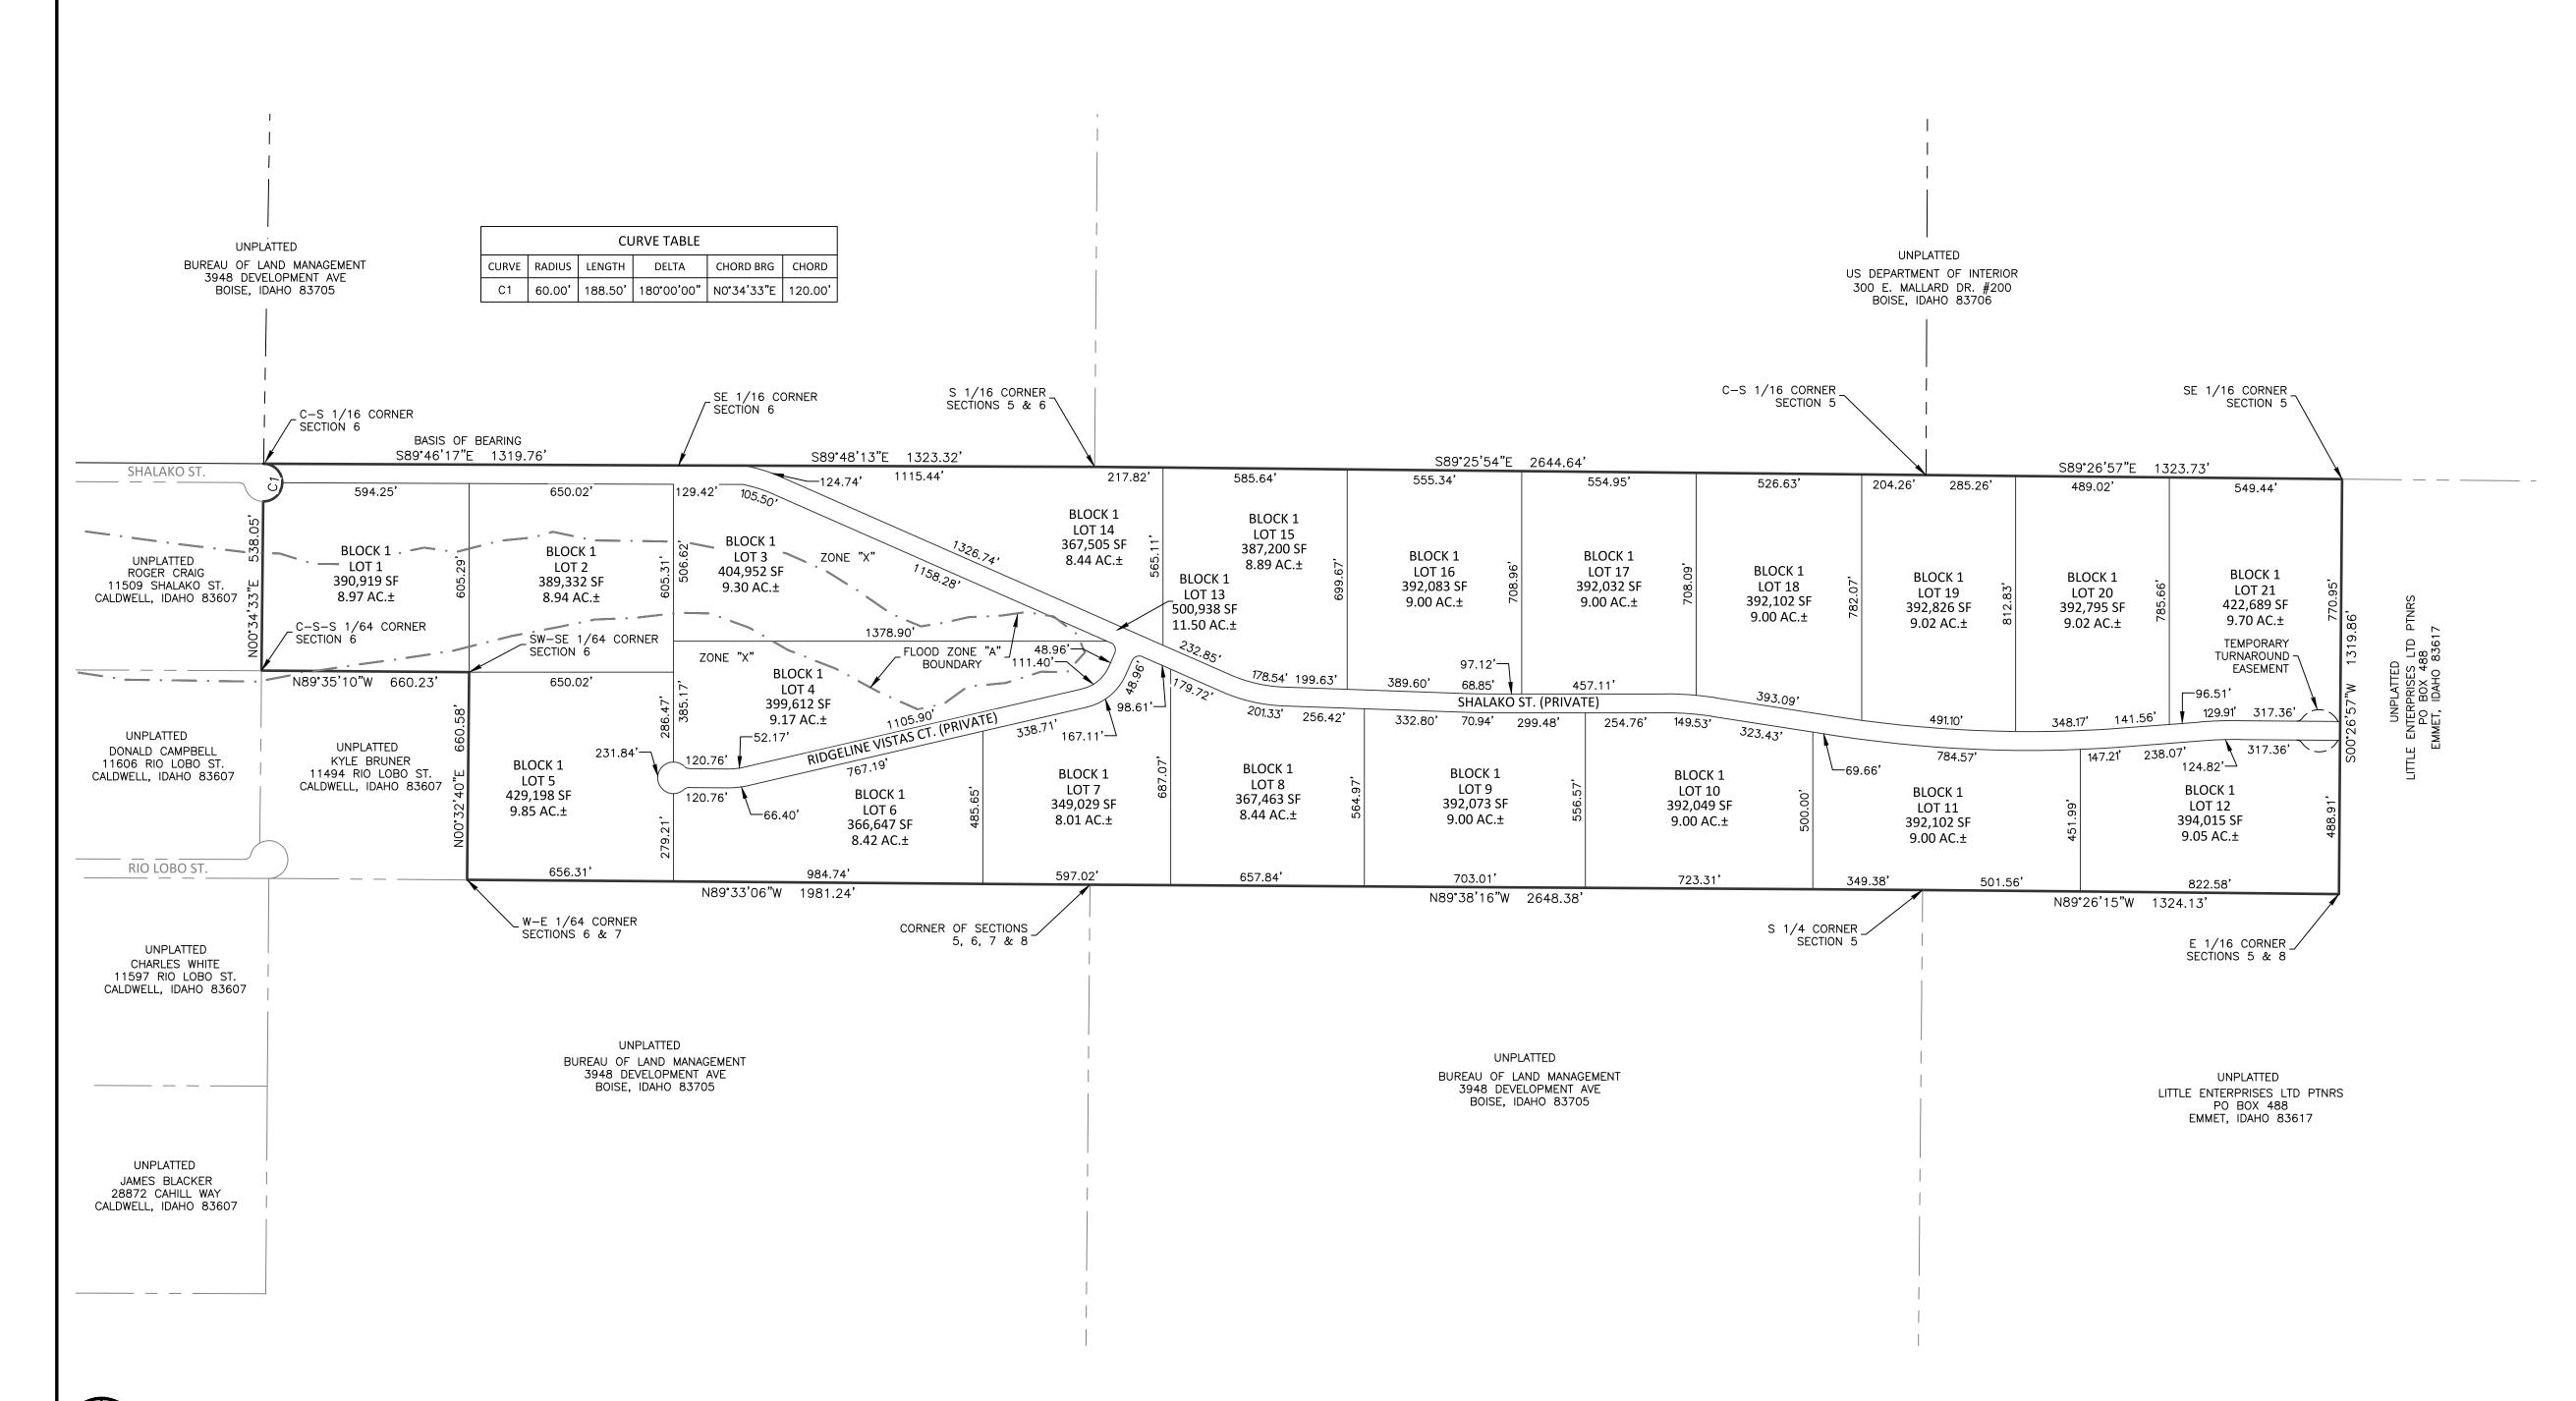

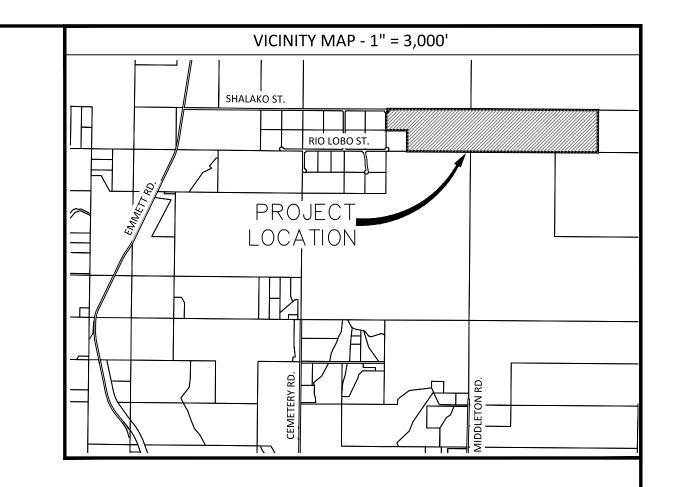

LEGEND			
	BOUNDARY LINE	BLOCK #	BLOCK NUMBER
	OFFSITE PROPERTY LINE	(#)	LOT NUMBER
	ROAD CENTERLINE	(R-R)	ZONING
	SECTION LINE	(,	
	LOT LINE		ASPHALT
· · · _	FLOW LINE		GRAVEL

BUILDING ENVELOPE

INDEX OF DRAWINGS

SHEET NO.	SHEET TITLE
SHEET PP1.0	PRELIMINARY PLAT
SHEET PP2.0	EXISTING CONDITIONS

SHEETS PP3.0-PP3.3 PRELIMINARY ENGINEERING AND REVEGETATION PLAN

PRELIMINARY PLAT DATA

SITE DATA				
CURRENT ZONING	CR-R-R	CONDITIONAL	RURAL	RESIDENTIA

TOTAL AREA OF SITE 190.72 ACRES 190.72 ACRES AREA PROPOSED R-R

AREA COMMON LOT PRIVATE ROAD

OVERALL SINGLE FAMILY RESIDENTIAL LOT DATA (ZONE CR-R-R)

RESIDENTIAL LOTS 190.72 OVERALL ACREAGE RESIDENTIAL ACREAGE 179.22 0.11 RES./ACRE

349,029 SQ. FEET 8.01 ACRE 390,341 SQ. FEET 8.96 ACRES MINIMUM RESIDENTIAL LOT SIZE AVERAGE RESIDENTIAL LOT SIZE

GENERAL UTILITY EASEMENT

FRONT AND REAR 10 FEET AS SHOWN HEREON

TEMPORARY TURNAROUND EASEMENT AS SHOWN HEREON

FRONT AND REAR 20 FEET 10 FEET CORNER

PRELIMINARY PLAT NOTES

- 1. THIS PROPERTY IS SUBJECT TO DEVELOPMENT AGREEMENT NO. 033 PER INSTRUMENT NUMBER 2021-034824.
- 2. THE HOMEOWNER'S ASSOCIATION, UNDERLYING PROPERTY OWNER OR ADJACENT PROPERTY OWNER IS RESPONSIBLE FOR ALL STORM DRAINAGE FACILITIES OUTSIDE THE PUBLIC RIGHT-OF-WAY, INCLUDING ALL ROUTINE AND HEAVY MAINTENANCE.
- 3. AS SHOWN HEREON, A PORTION OF THIS PLAT IS LOCATED WITHIN ZONE A, PER FLOOD INSURANCE RATE MAP, PANEL 150 OF 575, MAP NUMBER 16027C0150F, DATED MAY 24,

20 FEET

4. LOT 13, BLOCK 1 IS A COMMON LOT FOR THE PURPOSE OF A PRIVATE ROAD THAT SHALL BE OWNED AND MAINTAINED BY THE HOMEOWNER'S ASSOCIATION OR ASSIGNS.

SURVEY CONTROL NOTES


RIDGELINE VISTAS SUBDIVISION

1. ALL SURVEY DATA IS BASED ON THE NAD83 STATE PLANE COORDINATE SYSTEM (IDAHO WEST 1103) AND VERTICAL (NAVD88) DATUM.

PRELIMINARY PLAT CANYON COUNTY, IDAHO

PRELIMINARY - NOT FOR CONSTRUCTION

REVISIONS ITEM DATE AGENCY COMMENTS 6/1/22 AGENCY COMMENTS

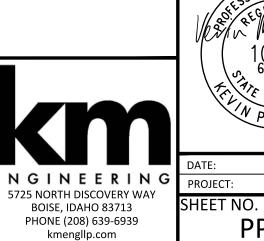


10/27/21 18-168

Plan Scale: 1" = 300'

OWNER/DEVELOPER RIDGELINE VISTAS, LLC PHONE: (208) 867-5309 2150 W. PACIFIC RIDGE EAGLE, ID 83616

ENGINEERING CONSULTANT KM ENGINEERING, LLP 5725 N DISCOVERY WAY BOISE, IDAHO 83713 PHONE: (208) 639-6939 FAX: (208) 639-6930 CONTACT: KEVIN MCCARTHY, P.E.

EMAIL: kevin@kmengllp.com

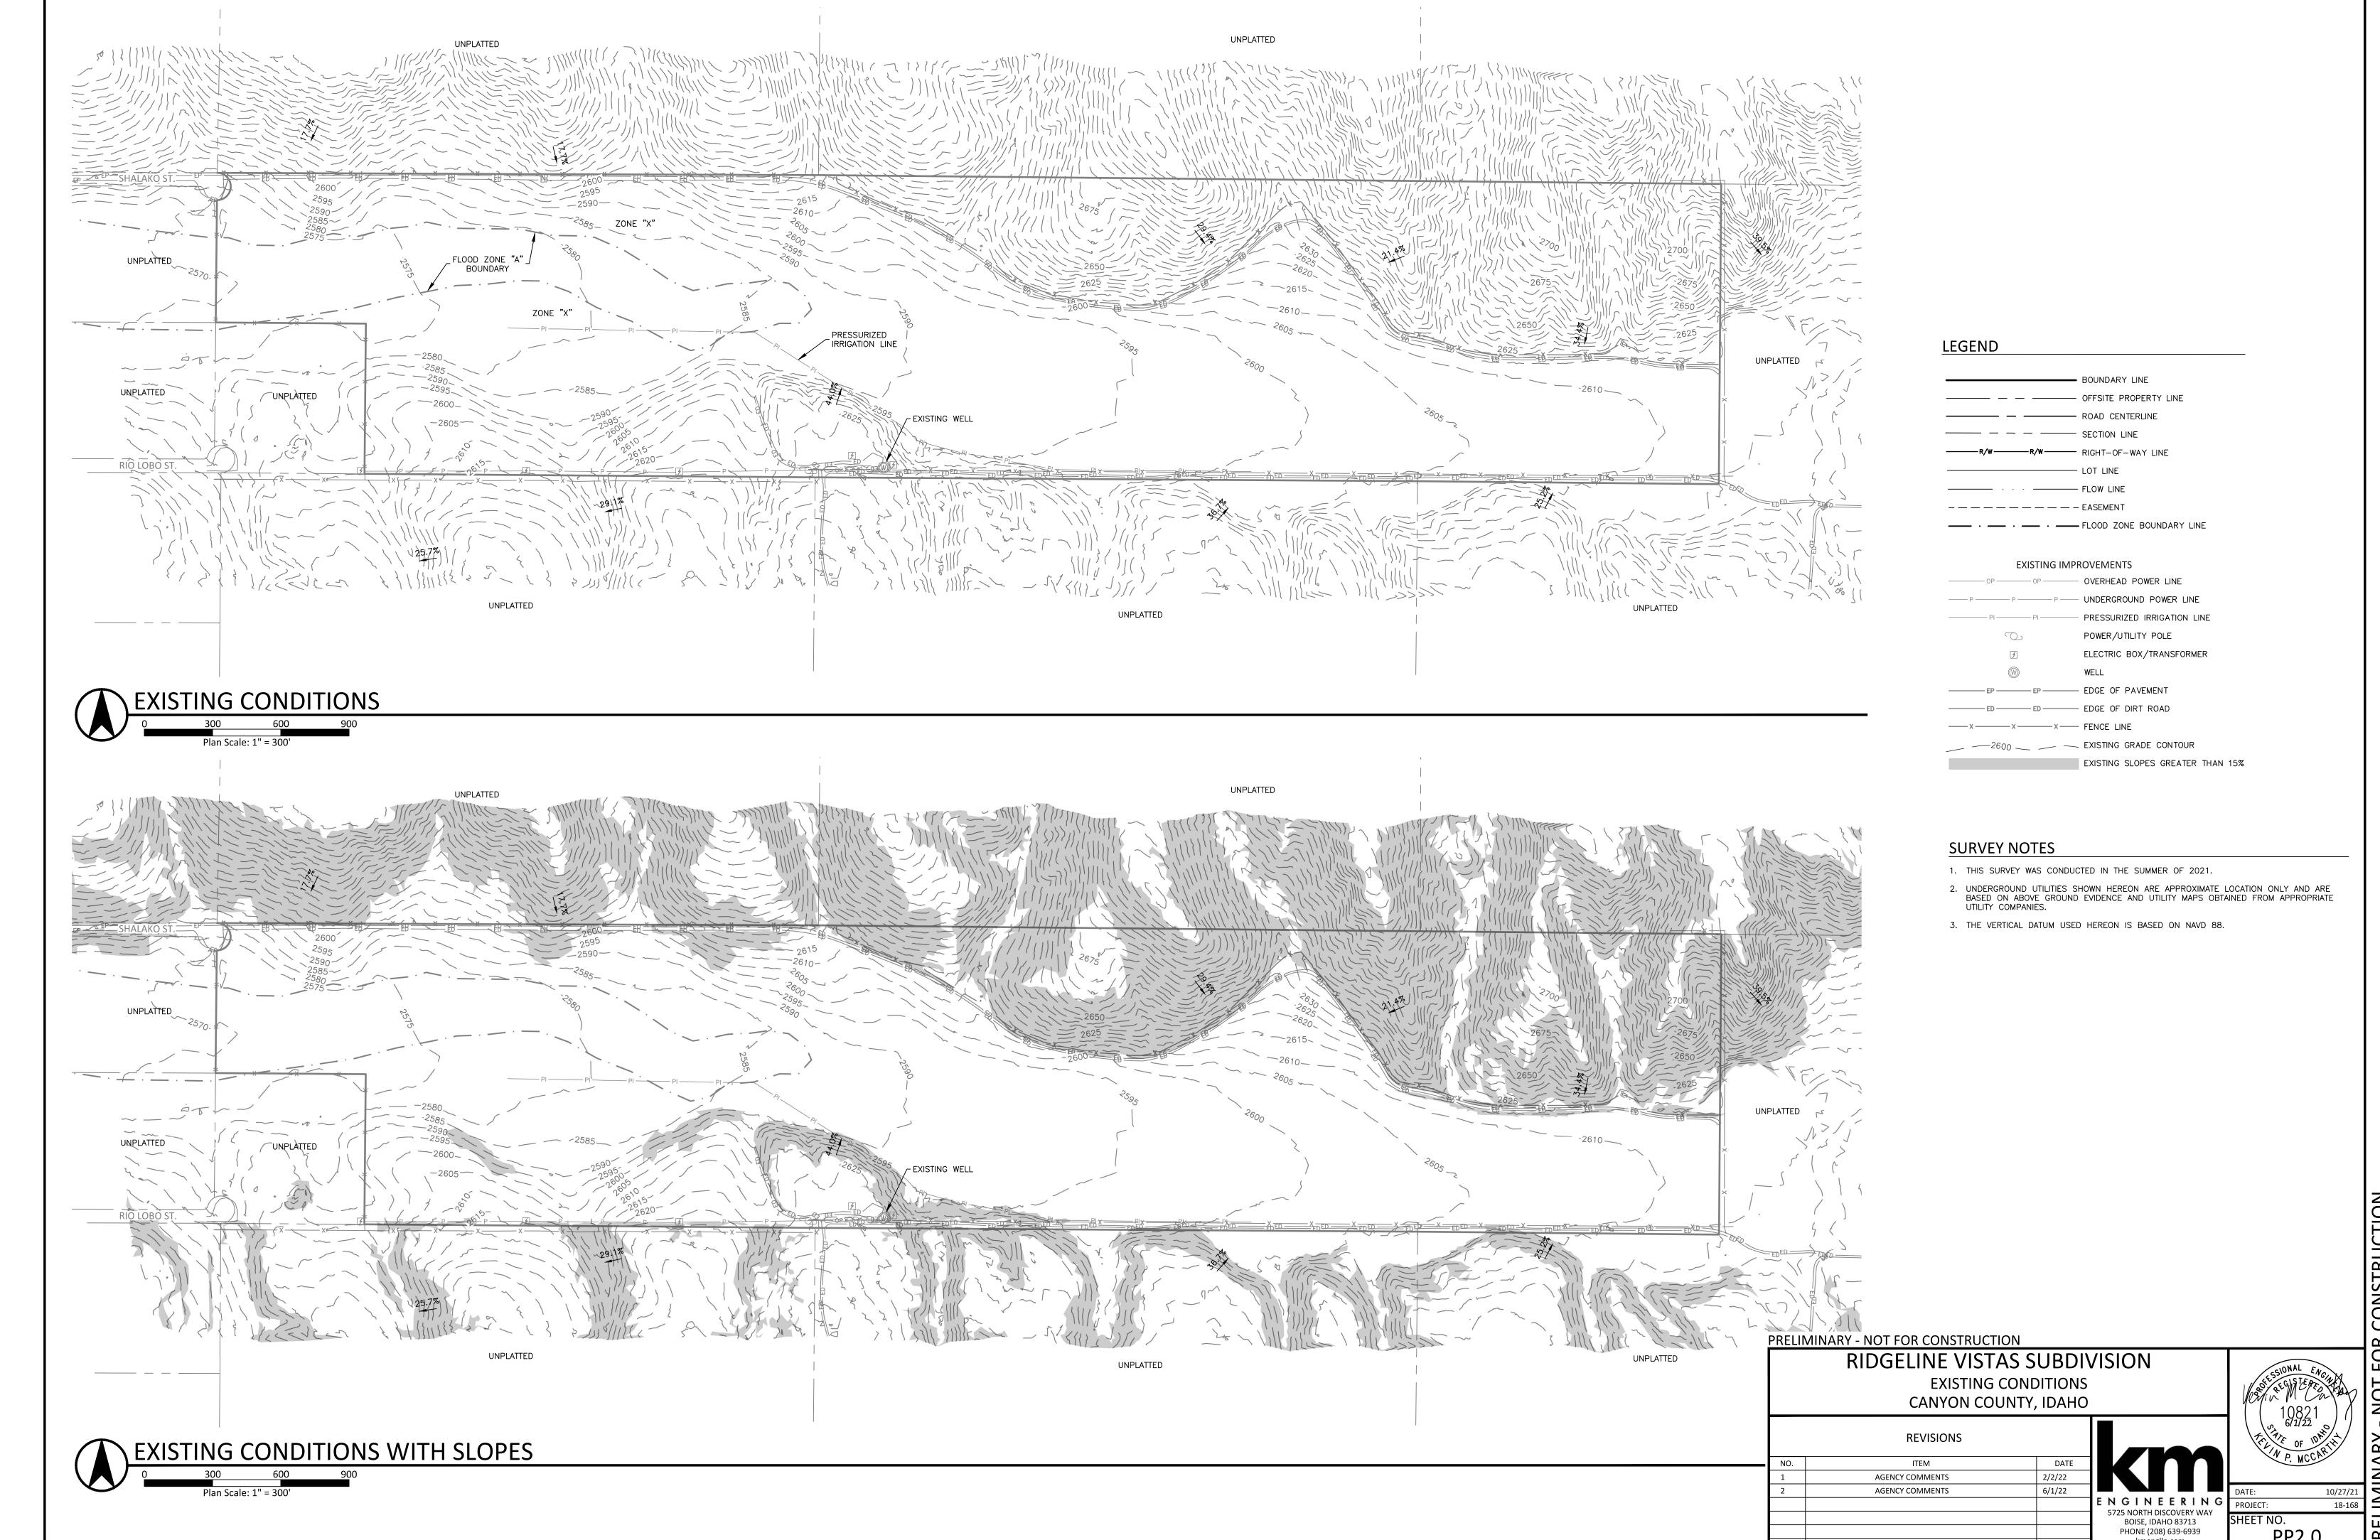


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CENTER-TO-EOP | CENTER-TO-EOP 2% SLOPE └ 3.0" ASPHALT PAVEMENT \ 6" OF 3/4"-MINUS CRUSHED AGGREGATE BASE 12" OF PIT RUN OVER COMPACTED

TYPICAL TWO LANE PRIVATE ROAD SECTION

1. STREET SECTION THICKNESS MAY BE REVISED DURING FINAL DESIGN.

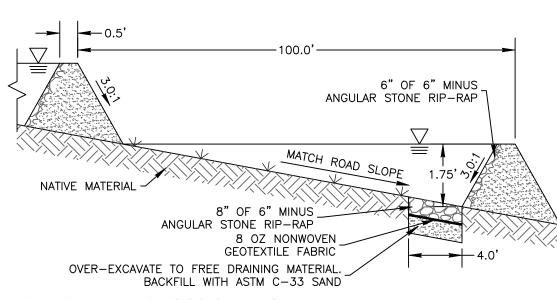

CHECK DAM CROSS SECTION

- 1. CHECK DAMS TO BE CONSTRUCTED OF CLAY SOIL TO MINIMIZE SEEPAGE OR ANGULAR ROCKS FOR CONVEYANCE SWALES.
- 2. SIDE SLOPES AND CHECK DAMS SHALL COMPLY WITH AASHTO CLEAR ZONE GUIDELINES

- 2. SANITARY SEWER FOR EACH LOT WILL BE PROCESSED USING AN ON-SITE SEPTIC TANK SYSTEM.
- 3. ALL DOMESTIC WATER WELLS AND SANITARY SEWER SEPTIC SYSTEMS WILL BE INSTALLED IN ACCORDANCE WITH THE IDAHO DEPARTMENT OF ENVIRONMENTAL QUALITY, SECTION 58.01.03 AS WELL AS CANYON COUNTY REQUIREMENTS.
- 4. CONSTRUCTION OF THE FOLLOWING IMPROVEMENTS WILL BE IN COMPLIANCE WITH CANYON COUNTY CODES AND SPECIFICATIONS: WATER; DRAINAGE; AND SEWER.
- 5. ALL STREETS SHALL BE PRIVATE ROADS. ROADWAYS WILL BE CONSTRUCTED TO AT LEAST MINIMUM CANYON COUNTY STANDARDS. SEE THE PRELIMINARY ROADWAY CROSS—SECTION, THIS SHEET.
- 6. STORM DRAINAGE FROM LOT 13, BLOCK 1, THE PRIVATE ROADWAY SHALL BE COLLECTED IN BORROW DITCHES WITHIN THE BOUNDARY OF SAID LOT 13, BLOCK 1.
- 7. HISTORIC DRAINAGE FLOW PATTERNS WILL BE MAINTAINED WITH FINAL GRADING.
- 8. ALL EXISTING WELLS ARE APPROXIMATE IN LOCATION AND WILL BE PRESERVED WHERE POSSIBLE. ANY WELL ABANDONMENT SHALL BE COMPLETED IN ACCORDANCE WITH THE REQUIREMENTS OF THE IDAHO DEPARTMENT OF WATER RESOURCES (IDWR) AND IDAHO CODE. THE CONTRACTOR SHALL RETAIN A LICENSED WELL DRILLER FOR ABANDONMENT. COORDINATE WITH ROB WHITNEY AT IDWR WESTERN REGION (334-2190).
- 9. FINISH GRADES AT SUBDIVISION BOUNDARIES SHALL MATCH EXISTING GRADES.
- 10. BORROW DITCHES WILL BE PROTECTED VIA THE USE OF STRAW WADDLES AND CHECK DAMS. IF DAMAGE OCCURS DURING CONSTRUCTION, THE CONTRACTOR SHALL REPAIR THESE FACILITIES AS NEEDED.

FIELD VERIFICATION OF QUANTITIES SHALL BE THE RESPONSIBILITY OF THE CONTRACTOR. DISTURBED AREAS ON

GRADING LEGEND

--- GRADE BREAK

BUILDING ENVELOPE LIMITS OF GRADING

ESTABLISHMENT AND GROWTH. TOPSOIL DISTRIBUTION
ONCE THE GENERAL EARTHWORK IS COMPLETE AND FINE GRADING HAS BEEN ACCOMPLISHED, THE TOPSOIL SHALL BI REDISTRIBUTED OVER AREAS TO A MINIMUM DEPTH OF FOUR (4) INCHES. WHERE NEEDED, SLOPES SHALL BE GRADED WITH SERRATION TO HOLD THE TOPSOIL ADEQUATELY. THE TOPSOIL SHALL BE SPREAD AND LIGHTLY COMPACTED

JTILIZING A BULLDOZER TRACTOR OR OTHER METHOD WITH EQUAL CAPABILITY. IT IS OUR RECOMMENDATION THAT ANY NECESSARY MECHANICAL MEANS OF EROSION CONTROL BE ACCOMPLISHED AS GRADING IS COMPLETED. REVEGETATION SEEDING SHALL FOLLOW IMMEDIATELY AFTER TOPSOIL PLACEMENT AND FINE GRADING IN ORDER TO

REVEGETATION NOTES

<u>EXISTING TOPOGRAPHY & VEGETATION</u> THE AREA TO BE REVEGETATED, AS OUTLINED ON THE PLAN

WITH THE BOISE AREA. THE SLOPES TO BE AFFECTED VARY IN DEGREE AND ASPECT. THE EXISTING VEGETATION CONSISTS PRIMARILY OF NATIVE DRYLAND SHRUBS, GRASSES, AND

CONSISTS OF FOOTHILL SLOPES AND RAVINES ASSOCIATED

<u>SITE PREPARATION/ TOPSOIL REMOVAL</u>
THE EARTHWORK PROCESS SHALL BEGIN WITH CLEARING

PROVIDE SOIL TEXTURE IMPROVEMENT, OR REMOVED AND DISPOSED OF. NATURAL TOPSOIL OCCURS AT VARYING DEPTHS ON THE PROJECT SITE. THE TOPSOIL SHALL BE EXCAVATED AND STOCKPILED AT DESIGNATED STORAGE AREAS

MINIMAL LARGE SHRUBS FROM THE AREAS TO BE DISTURBED WOODY STEMS AND BRANCHES WILL BE CHIPPED ON SITE 1

PRIOR TO THE PROPOSED GRADING OPERATION. SAMPLES OF STOCKPILED SOIL SHALL BE TAKEN AND TESTED FOR SPECIFIC SOIL STRUCTURES AND FERTILITY. TEST RESULTS

WILL BE THE BASIS FOR DETERMINING WHICH, IF ANY, SOIL AMENDMENTS WILL BE NECESSARY TO PROMOTE PLANT

FORBS, AND INTRODUCED WEEDS.

ELIMINATE SURFACE CRUSTING AND TO FACILITATE BETTER ROOT PENETRATION, THE SURFACE SHALL BE SCARIFIED OR AGAIN "CAT TRACKED" PRIOR TO SEEDING. <u>SEEDING</u>
DRILL SEEDING TO SLOPES LESS THAN 4:1 AND BROADCAST

SEEDING BY HYDROSEEDER FOR GREATER SLOPES SHALL BE USED TO APPLY THE SEED TO THE PROJECT SITE. THE SEED MIX OR MIXES SHALL BE DEFINED ON THE FINAL CONSTRUCTION PLANS.

HE SEEDING WILL RELY UPON NATURAL PRECIPITATION FOR SEED GERMINATION AND ESTABLISHMENT. MINIMUM GERMINATION OF 90 PERCENT IS REQUIRED. CONTRACTOR SHALL RESEED OR OVERSEED AS NECESSARY TO MEET THIS GERMINATION. TEMPORARY IRRIGATION WILL BE NECESSARY IF THIS GERMINATION IS NOT MET OR IF SEED IS NOT INSTALLED WITHIN NON-IRRIGATED NATIVE SEED RECOMMENDED WINDOW.

NON IRRIGATED NATIVE SEED RECOMMENDED WINDOW: SPRING SEEDING - AFTER FROST LEAVES GROUND AND TEMPERATURES ARE CONSISTENT

±FEB. 15-MAY 15 FALL SEEDING - AFTER FIRST FROST IN FALL. ±OCTOBER 15- NOVEMBER 15 DO NOT APPLY SEED ON TOP OF

AMENDMENTS AND FERTILIZERS WILL BE ADDED TO THE TOPSOIL AS DETERMINED FROM THE SOIL TESTS, AND ONLY AS NECESSARY.

TO PROVIDE PROTECTIVE SEED COVER, AID IN EROSION CONTROL AND HELP TO RETAIN MOISTURE, A GRASS-FIBER MULCH AND SYNTHETIC TACKIFIER SHALL BE BROADCAST IN A HYDROMULCH PROCESS FOLLOWING SEEDING. THE GRASS-FIBER MULCH IS BROADCAST AT A MINIMUM RATE OF TWO THOUSAND (1,000) POUNDS PER ACRE.

EROSION CONTROL
UNDER NORMAL CIRCUMSTANCES AND ADHERENCE TO THE CONSTRUCTION PRACTICES DESCRIBED IN THE REPORT, THE ABOVE RECOMMENDED EROSION CONTROL MEASURES WILL PROVIDE A STABLE SLOPE CONDITION. TO AVOID INCIDENTA EROSION IT IS IMPERATIVE THAT THE SLOPES, ONCE PREPARED, REMAIN UNDISTURBED UNTIL SEEDING COMMENCES.


A 90% VEGETATIVE COVER IS RECOMMENDED TO CONTROL

EROSION. IF AN UNUSUAL SEASON OCCURS WITH EXCESSIV RAINFALL AND RUN-OFF, THE FOLLOWING MEASURES SHALL BE TAKEN. SURFACE CONDITIONS SHALL BE MONITORED ON A DAILY BASIS. IF EROSION DETRIMENTAL TO THE SLOPE IS OBSERVED OR ANTICIPATED DUE TO EXCESSIVE RAINFALL, ONE OR MORE REMEDIAL MEASURES SHALL BE IMPLEMENTED AS RECOMMENDED BY THE PROJECT GEOTECHNICAL ENGINEER. SURFACE RUNOFF SHALL BE CONTROLLED WITH INTERCEPTOR DITCHES CONSTRUCTED AT THE TOP OF SLOPI AND AT DOWN SLOPE INTERVALS AS REQUIRED. TRENCHING SHALL OCCUR AT SHALLOW ANGLES TO THE CONTOURS TO MINIMIZE FLOW VELOCITY. UNDER SEVERE RUNOFF CONDITIONS DITCHES MAY REQUIRE EROSION CONTROL MEASURES TO COLLECT SEDIMENT AND PREVENT DITCH EROSION. ROCK CHECK DAMS SHALL BE USED TO CONTRO SWALE EROSION. SHOULD ERODED SEDIMENTS THREATEN ADJACENT PROPERTIES OR DRAINAGE SYSTEMS, THE TOE OF THE SLOPE SHALL BE LINED WITH BALES OR SILT FENCES TO CONTAIN SEDIMENTS ON-SITE.

GENERAL NOTES
FIELD VERIFICATION OF QUANTITIES SHALL BE THE
RESPONSIBILITY OF THE CONTRACTOR. DISTURBED AREAS ON REVEGETATION PLAN ARE SCHEMATIC.

REVEGETATION SUMMARY

AREA TO BE HYDROSEEDED 302,828 SF ± (6.95 AC ±)

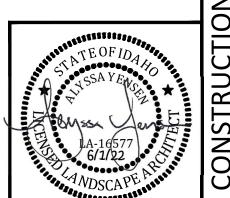

PRELIMINARY - NOT FOR CONSTRUCTION


RIDGELINE VISTAS SUBDIVISION PRELIMINARY ENGINEERING AND REVEGETATION PLAN CANYON COUNTY, IDAH

REVISIONS			
NO.	ITEM	DATE	
1	AGENCY COMMENTS	2/2/22	
2	AGENCY COMMENTS	6/1/22	

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E	
	ENGINEERING
	5725 NORTH DISCOVERY WAY
	BOISE, IDAHO 83713
	PHONE (208) 639-6939
	kmengllp.com



10/27/23

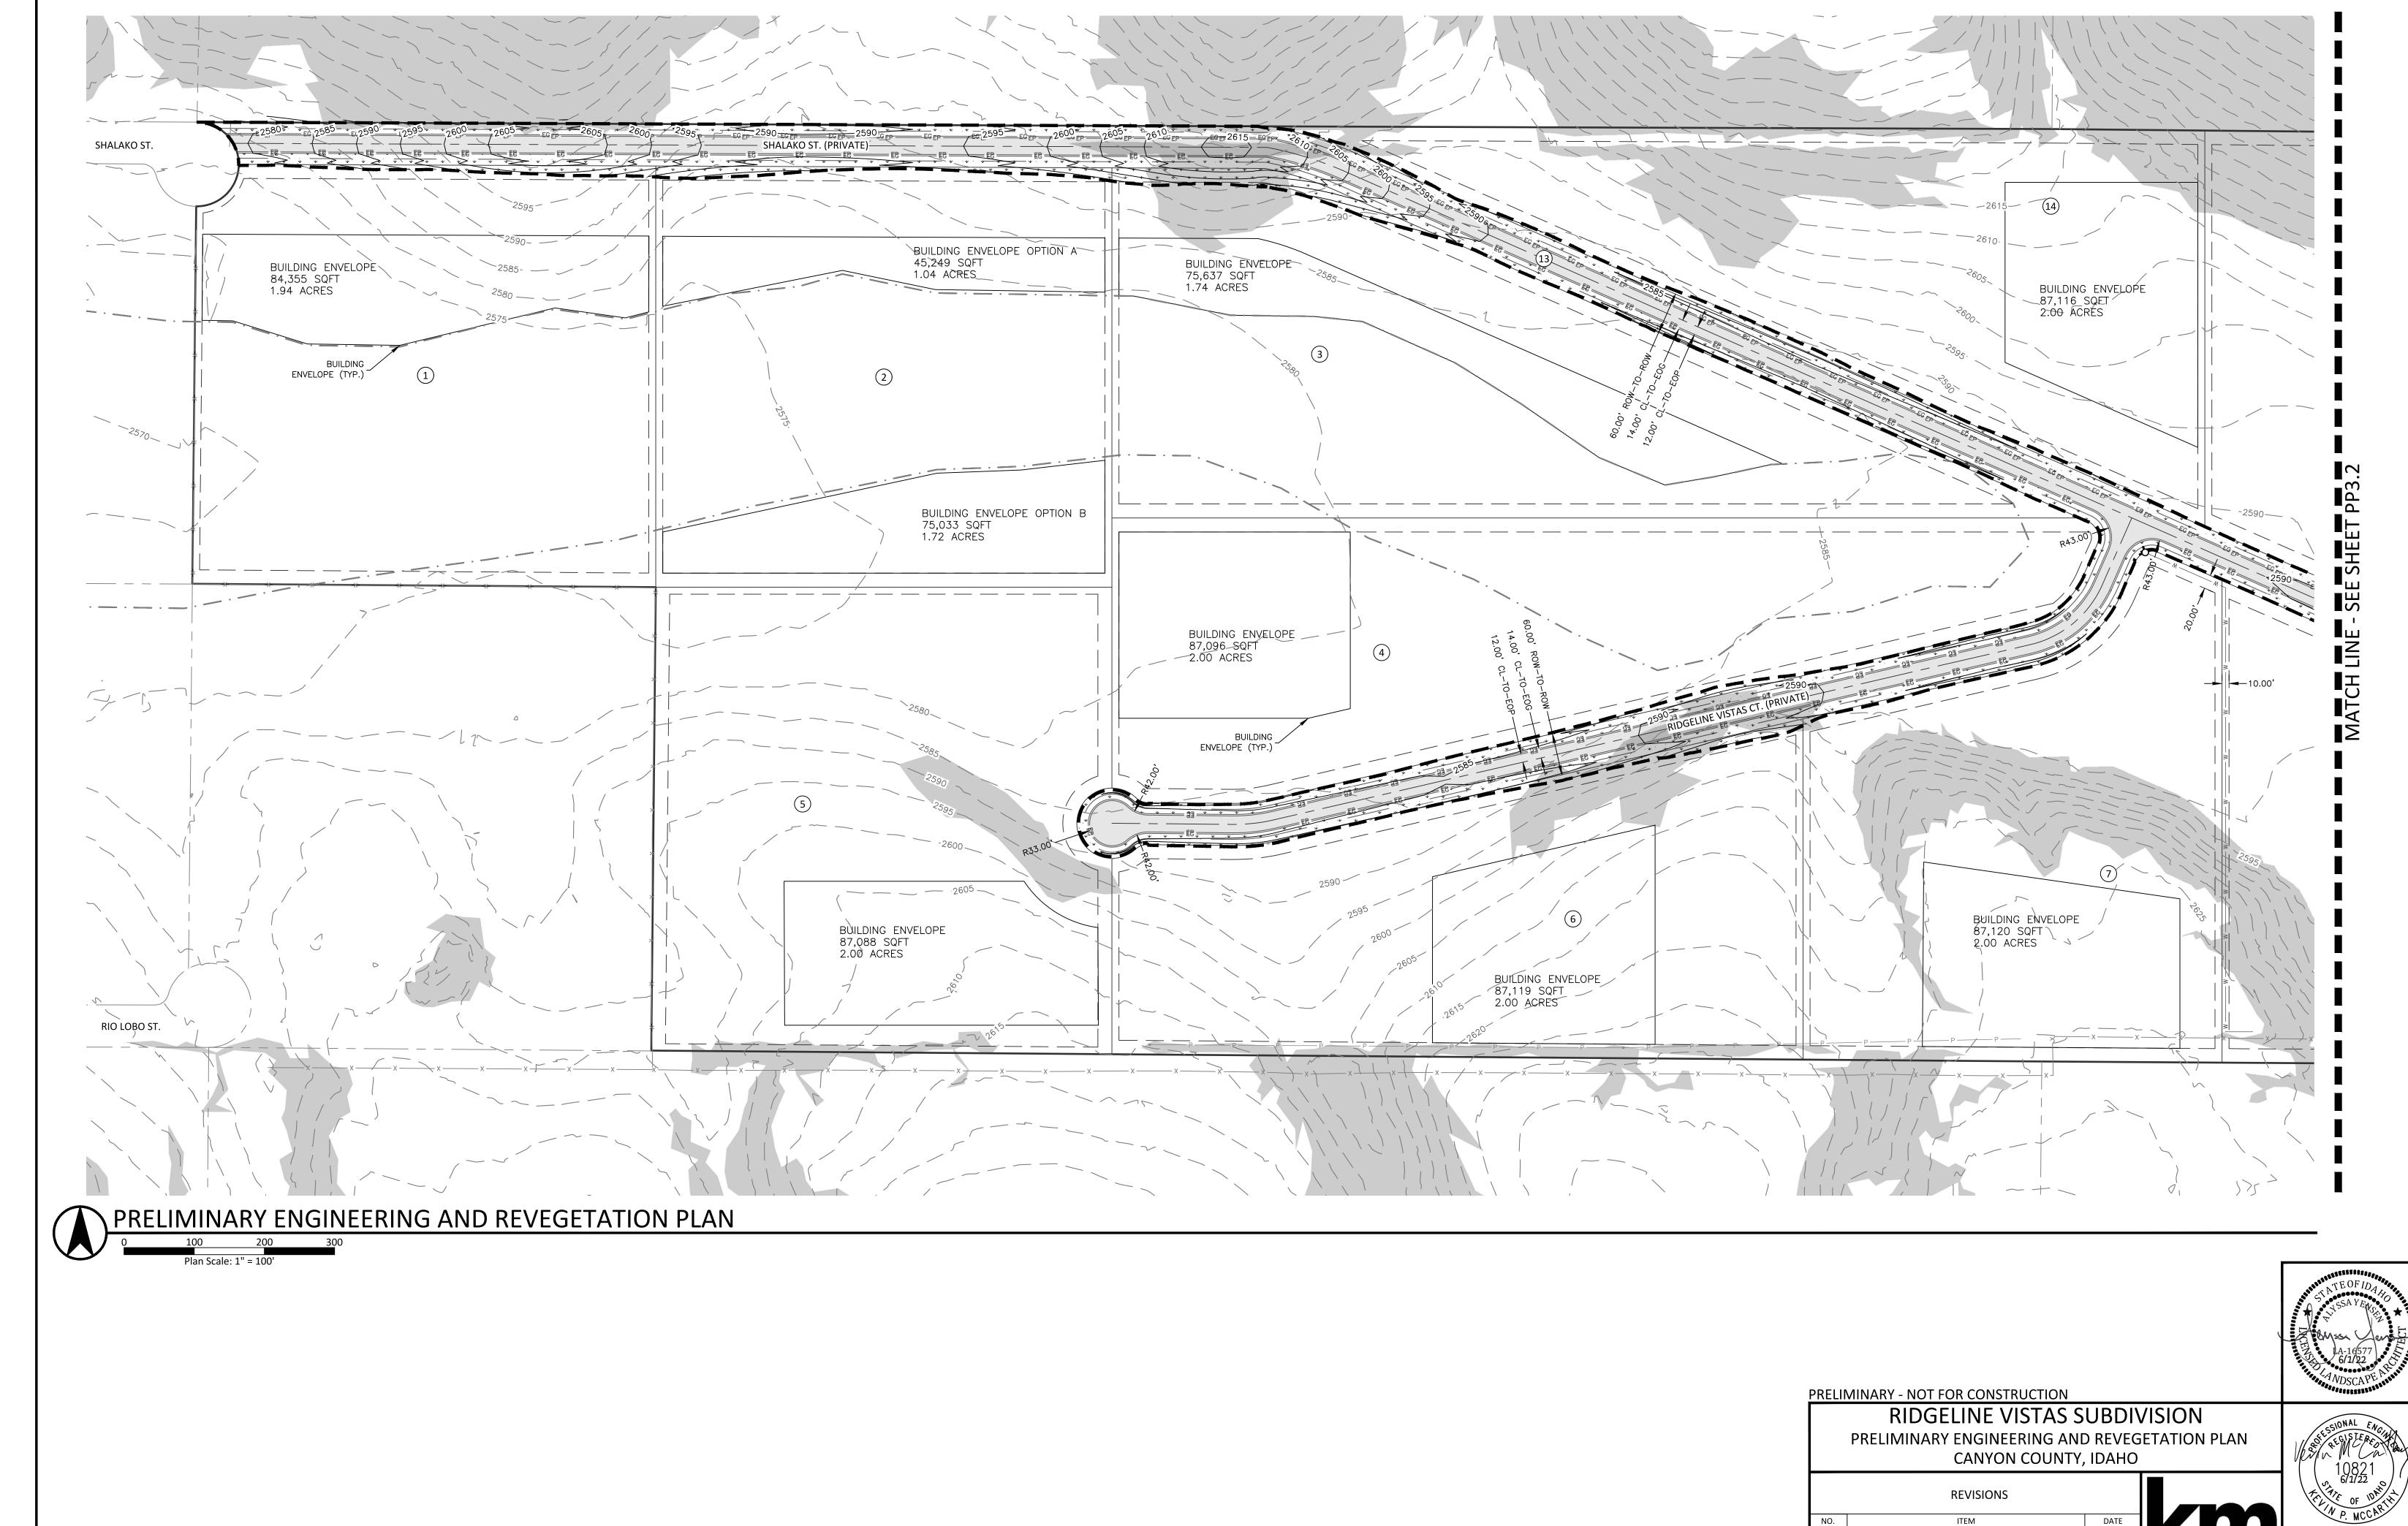

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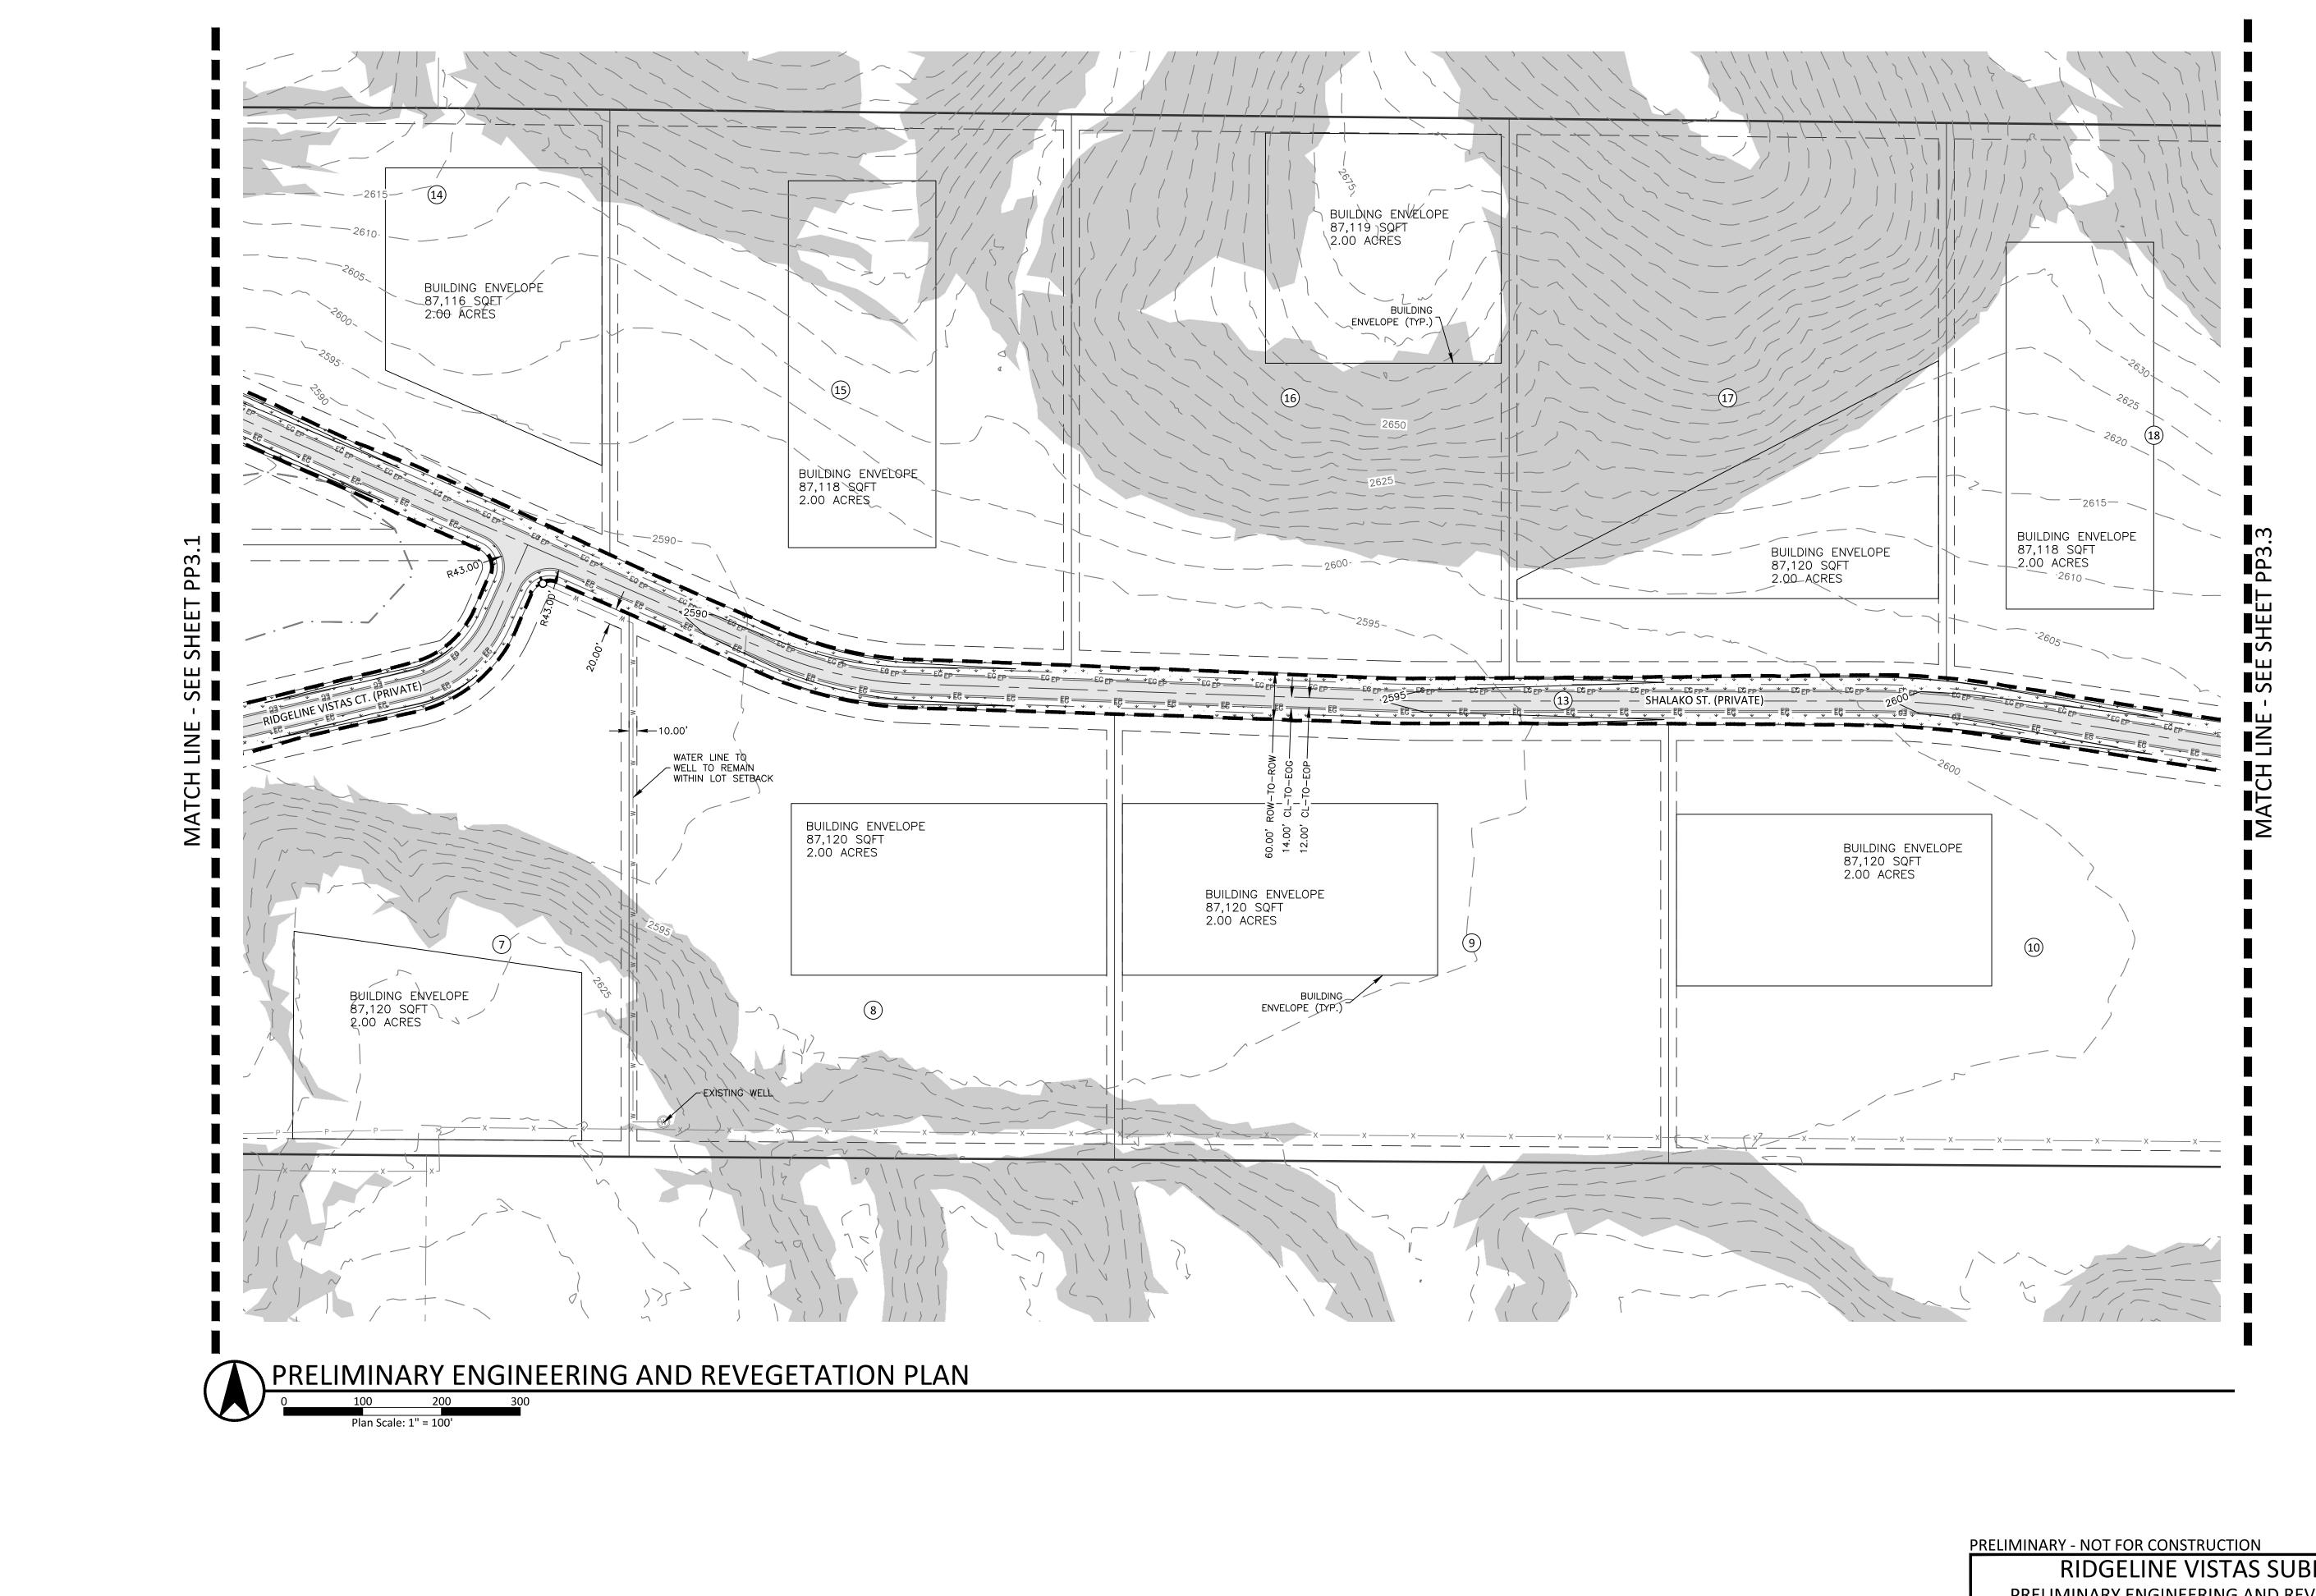
AGENCY COMMENTS

AGENCY COMMENTS

6/1/22

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5725 NORTH DISCOVERY WAY
BOISE, IDAHO 83713
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RIDGELINE VISTAS SUBDIVISION PRELIMINARY ENGINEERING AND REVEGETATION PLAN CANYON COUNTY, IDAHO

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NO.	ITEM	DATE
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	ENGINEERING 5725 NORTH DISCOVERY WAY BOISE, IDAHO 83713 PHONE (208) 639-6939	DA PR SH
	kmengllp.com	

DATE: 10/27/21

PROJECT: 18-168


PP3.2

PRELIMINARY - NOT FOR CONSTRUCTION

RIDGELINE VISTAS SUBDIVISION PRELIMINARY ENGINEERING AND REVEGETATION PLAN CANYON COUNTY, IDAHO

REVISIONS			
NO.	ITEM	DATE	
1	AGENCY COMMENTS	2/2/22	
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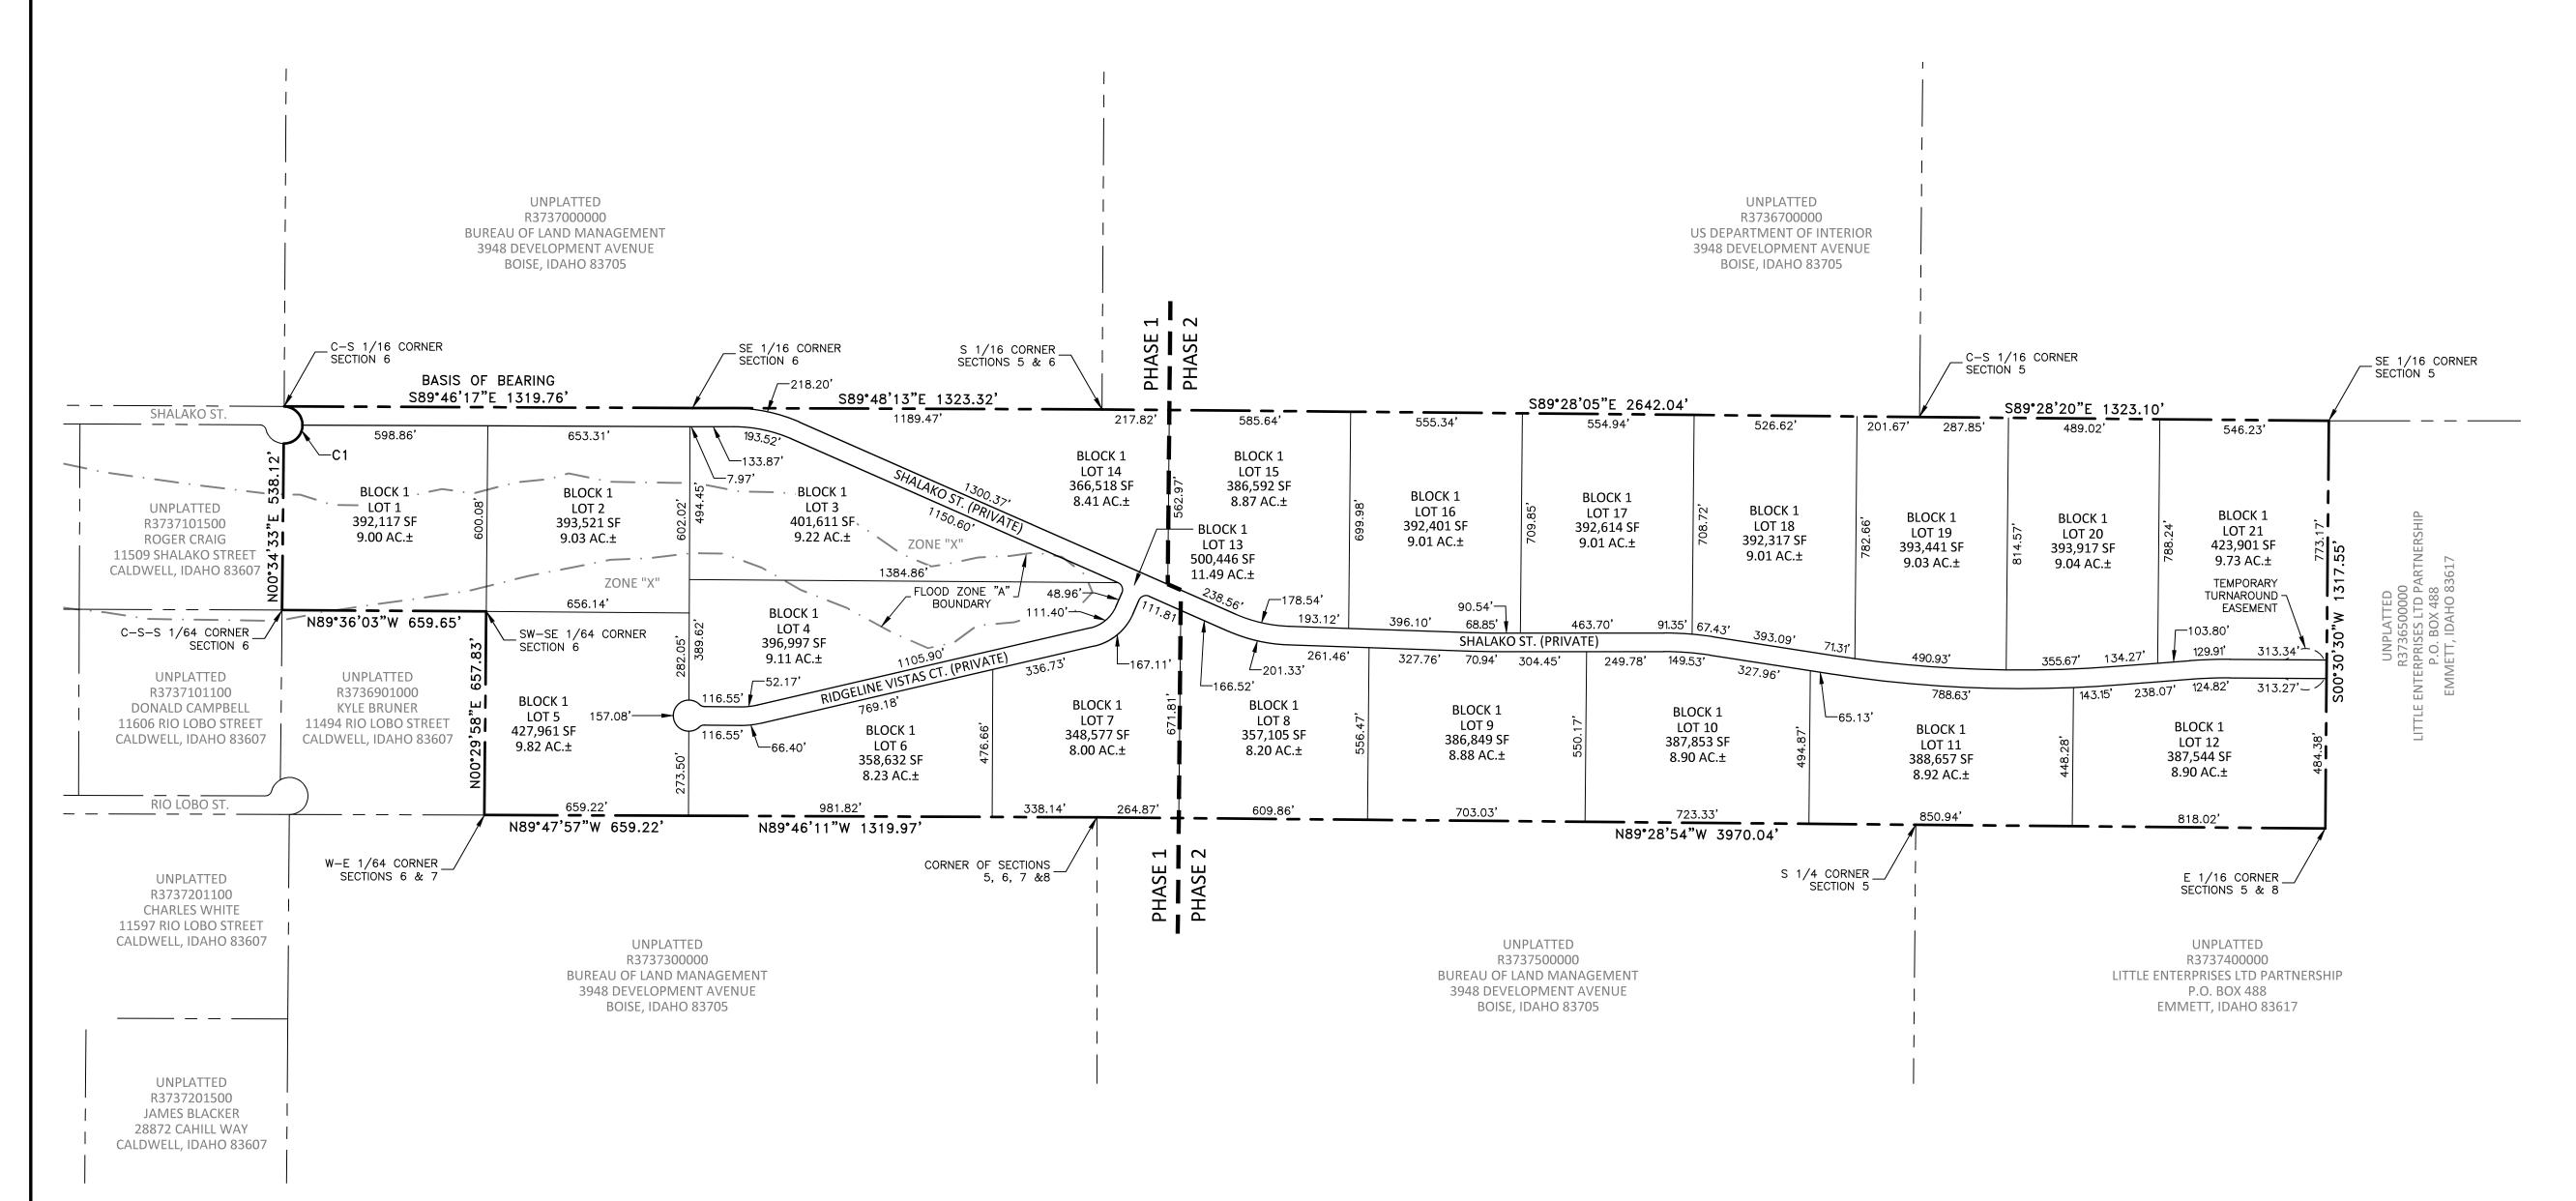
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DATE	
/2/22	
/1/22	
	5725 NORTH DISCOVERY WAY BOISE, IDAHO 83713 PHONE (208) 639-6939 kmengllp.com

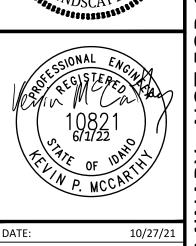



TE: 10/27/21
DJECT: 18-168
EET NO.
PP3.3

PRELIMINARY PLAT SHOWING RIDGELINE VISTAS SUBDIVISION

THE S 1/2 OF THE SW 1/4 AND THE SW 1/4 OF THE SE 1/4 OF SECTION 5, AND A PORTION OF THE S 1/2 OF THE SE 1/4 OF SECTION 6, TOWNSHIP 5 NORTH, RANGE 2 WEST, BOISE MERIDIAN, CANYON COUNTY, IDAHO



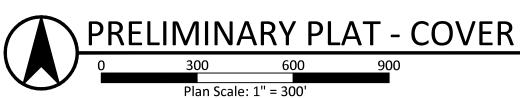

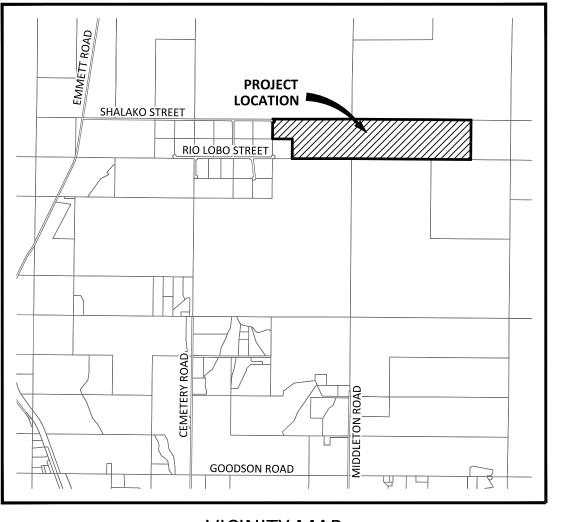

VICINITY MAP

PRELIMINARY PLAT DATA

PARCEL NUMBER(S) PROPERTY ADDRESS

CITY/STATE/ZIP:

MAXIMUM LOT SIZE:

MINIMUM LOT SIZE:

R3736900000 & R3736800000 O SHALAKO STREET CALDWELL, IDAHO 83607

CR-R-R

(CONDITIONAL RURAL RESIDENTIAL)

CURRENT ZONING: PROJECT AREA: DEVELOPABLE LOTS:

COMMON LOT (PRIVATE ROADWAY):

±189.84 ACRES ±178.35 ACRES ±11.49 ACRES 9.83 ACRES 8.00 ACRES 8.92 ACRES

AVERAGE LOT SIZE: 0.11 UNITS PER ACRE

NUMBER OF LOTS DEVELOPABLE LOTS: COMMON LOT (PRIVATE ROADWAY): TOTAL NUMBER OF LOTS:

EASEMENT DATA (GENERAL UTILITY EASEMENT)

10 FEET 10 FEET FRONT AND REAR: SETBACK DATA

FRONT & REAR: CORNER:

PRELIMINARY PLAT NOTES

1. THE HOMEOWNER'S ASSOCIATION, UNDERLYING PROPERTY OWNER OR ADJACENT PROPERTY OWNER IS RESPONSIBLE FOR ALL STORM DRAINAGE FACILITIES OUTSIDE THE PUBLIC RIGHT-OF-WAY, INCLUDING ALL ROUTINE AND HEAVY MAINTENANCE.

10 FEET 20 FEET

- 2. AS SHOWN HEREON, A PORTION OF THIS PLAT IS LOCATED WITHIN ZONE A, PER FLOOD INSURANCE RATE MAP, PANEL 150 OF575, MAP NUMBER 16027C0150F, DATED MAY 24, 2011. A FLOOD STUDY AND LOMR APPLICATION IS IN THE PROCESS OF BEING COMPLETED FOR THIS PROPERTY. THE STUDY IS EXPECTED TO GIVE THIS AREA A ZONE "X" DESIGNATION AND BE APPROVED PRIOR TO THE FINAL PLAT
- 3. LOT 13, BLOCK 1 IS A COMMON LOT FOR THE PURPOSE OF A PRIVATE ROAD WHAT SHALL BE OWNED AND MAINTAINED BY THE HOMEOWNER'S ASSOCIATION OR ASSIGNS.

SURVEY CONTROL NOTES

1. ALL SURVEY DATA IS BASED ON THE NAD83 STATE PLANE COORDINATE SYSTEM (IDAHO WEST 1103) AND NAVD 88 VERTICAL DATUM.

INDEX OF DRAWINGS

PP1.0 COVER SHEET PP2.0 EXISTING CONDITIONS PP3.0 PRELIMINARY ENGINEERING & REVEGETATION PP3.1 PRELIMINARY ENGINEERING & REVEGETATION PP3.2 PRELIMINARY ENGINEERING & REVEGETATION PP3.3 PRELIMINARY ENGINEERING & REVEGETATION	PLAN PLAN

PROJECT TEAM

PROPERTY OWNER

NAME:
CONTACT:
ADDRESS:
CITY/STATE/ZIP:
PHONE:
· · · · · · · ·

ENGINEERING

RIDGELINE VISTAS SUBDIVISION

PRELIMINARY PLAT

CONTACT: ADDRESS: CITY/STATE/ZIP: KM ENGINEERING, LLP. KEVIN McCARTHY, P.E. 5725 N. DISCOVERY WAY BOISE, IDAHO 83713 208.639.6939 kevin@kmengllp.com

RIDGELINE VISTAS, LLC

2150 W. PACIFIC RIDGE EAGLE, IDAHO 83616 208.867.5309

BOUNDARY LINE BLOCK # — — — ADJACENT BOUNDARY LINE


——— — — SECTION LINE · — FLOW LINE — — SETBACK LINE

LEGEND

BLOCK NUMBER LOT NUMBER ZONING ASPHALT GRAVEL

BUILDABLE AREA

CANYON COUNTY, IDAHO **REVISIONS** NO. ITEM DATE AGENCY COMMENTS 6/1/22 AGENCY COMMENTS AGENCY COMMENTS 11/29/22

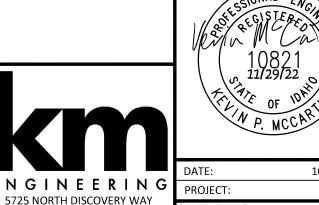

BOISE, IDAHO 83713

PHONE (208) 639-6939 kmengllp.com

10/27/21 18-168




BOISE, IDAHO 83713 PHONE (208) 639-6939 kmengllp.com

CENTER-TO-EOP | CENTER-TO-EOP 2% SLOPE 3.0" ASPHALT PAVEMENT \ 6" OF 3/4"-MINUS CRUSHED AGGREGATE BASE 12" OF PIT RUN OVER COMPACTED

TYPICAL TWO LANE PRIVATE ROAD SECTION

1. STREET SECTION THICKNESS MAY BE REVISED DURING FINAL DESIGN.

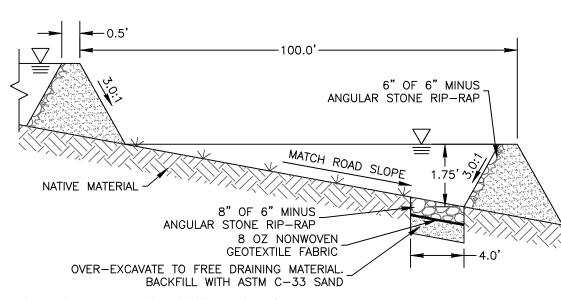

CHECK DAM CROSS SECTION

- 1. CHECK DAMS TO BE CONSTRUCTED OF CLAY SOIL TO MINIMIZE SEEPAGE OR ANGULAR ROCKS FOR CONVEYANCE SWALES.
- 2. SIDE SLOPES AND CHECK DAMS SHALL COMPLY WITH AASHTO CLEAR ZONE GUIDELINES

- 1. DOMESTIC WATER SERVICE WILL BE PROVIDED TO EACH LOT VIA PRIVATE WELL.
- 2. SANITARY SEWER FOR EACH LOT WILL BE PROCESSED USING AN ON-SITE SEPTIC TANK SYSTEM.
- 3. ALL DOMESTIC WATER WELLS AND SANITARY SEWER SEPTIC SYSTEMS WILL BE INSTALLED IN ACCORDANCE WITH THE IDAHO DEPARTMENT OF ENVIRONMENTAL QUALITY, SECTION 58.01.03 AS WELL AS CANYON COUNTY REQUIREMENTS.
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GENERAL NOTES

FIELD VERIFICATION OF QUANTITIES SHALL BE THE RESPONSIBILITY OF THE CONTRACTOR. DISTURBED AREAS ON REVEGETATION PLAN ARE SCHEMATIC.

GRADING LEGEND

2900 ____ EXISTING GRADE CONTOUR

---- GRADE BREAK

LIMITS OF GRADING

* * * * * * * AREA TO BE

REVEGETATION NOTES

EXISTING TOPOGRAPHY & VEGETATION
THE AREA TO BE REVEGETATED, AS OUTLINED ON THE PLAN,
CONSISTS OF FOOTHILL SLOPES AND RAVINES ASSOCIATED WITH THE BOISE AREA. THE SLOPES TO BE AFFECTED VARY IN DEGREE AND ASPECT. THE EXISTING VEGETATION CONSISTS

PRIMARILY OF NATIVE DRYLAND SHRUBS, GRASSES, AND

FORBS, AND INTRODUCED WEEDS. SITE PREPARATION/ TOPSOIL REMOVAL
THE EARTHWORK PROCESS SHALL BEGIN WITH CLEARING

ESTABLISHMENT AND GROWTH.

MINIMAL LARGE SHRUBS FROM THE AREAS TO BE DISTURBED. WOODY STEMS AND BRANCHES WILL BE CHIPPED ON SITE 1 PROVIDE SOIL TEXTURE IMPROVEMENT. OR REMOVED AND DISPOSED OF. NATURAL TOPSOIL OCCURS AT VARYING DEPTHS ON THE PROJECT SITE. THE TOPSOIL SHALL BE EXCAVATED AND STOCKPILED AT DESIGNATED STORAGE AREAS PRIOR TO THE PROPOSED GRADING OPERATION. SAMPLES OF STOCKPILED SOIL SHALL BE TAKEN AND TESTED FOR SPECIFIC SOIL STRUCTURES AND FERTILITY. TEST RESULTS WILL BE THE BASIS FOR DETERMINING WHICH, IF ANY, SOIL AMENDMENTS WILL BE NECESSARY TO PROMOTE PLANT

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ONCE THE GENERAL EARTHWORK IS COMPLETE AND FINE GRADING HAS BEEN ACCOMPLISHED, THE TOPSOIL SHALL BE REDISTRIBUTED OVER AREAS TO A MINIMUM DEPTH OF FOUR (4) INCHES. WHERE NEEDED, SLOPES SHALL BE GRADED WITH SERRATION TO HOLD THE TOPSOIL ADEQUATELY. THE TOPSOIL SHALL BE SPREAD AND LIGHTLY COMPACTED JTILIZING A BULLDOZER TRACTOR OR OTHER METHOD WITH EQUAL CAPABILITY. IT IS OUR RECOMMENDATION THAT ANY NECESSARY MECHANICAL MEANS OF EROSION CONTROL BE ACCOMPLISHED AS GRADING IS COMPLETED.

REVEGETATION SEEDING SHALL FOLLOW IMMEDIATELY AFTER TOPSOIL PLACEMENT AND FINE GRADING IN ORDER TO ELIMINATE SURFACE CRUSTING AND TO FACILITATE BETTER ROOT PENETRATION, THE SURFACE SHALL BE SCARIFIED OR AGAIN "CAT TRACKED" PRIOR TO SEEDING.

SEEDING
DRILL SEEDING TO SLOPES LESS THAN 4:1 AND BROADCAST SEEDING BY HYDROSEEDER FOR GREATER SLOPES SHALL BE USED TO APPLY THE SEED TO THE PROJECT SITE. THE SEED MIX OR MIXES SHALL BE DEFINED ON THE FINAL CONSTRUCTION PLANS.

WATER
THE SEEDING WILL RELY UPON NATURAL PRECIPITATION FOR SEED GERMINATION AND ESTABLISHMENT. MINIMUM GERMINATION OF 90 PERCENT IS REQUIRED. CONTRACTOR SHALL RESEED OR OVERSEED AS NECESSARY TO MEET THIS GERMINATION. TEMPORARY IRRIGATION WILL BE NECESSARY IF THIS GERMINATION IS NOT MET OR IF SEED IS NOT INSTALLED WITHIN NON-IRRIGATED NATIVE SEED RECOMMENDED WINDOW.

SPRING SEEDING - AFTER FROST LEAVES GROUND AND

NON IRRIGATED NATIVE SEED RECOMMENDED WINDOW:

TEMPERATURES ARE CONSISTENT ±FEB. 15-MAY 15

FALL SEEDING - AFTER FIRST FROST IN FALL. ±OCTOBER 15- NOVEMBER 15 DO NOT APPLY SEED ON TOP OF

AMENDMENTS AND FERTILIZERS WILL BE ADDED TO THE TOPSOIL AS DETERMINED FROM THE SOIL TESTS, AND ONLY AS NECESSARY.

MULCHING
TO PROVIDE PROTECTIVE SEED COVER, AID IN EROSION

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EROSION CONTROL
UNDER NORMAL CIRCUMSTANCES AND ADHERENCE TO THE CONSTRUCTION PRACTICES DESCRIBED IN THE REPORT, THE ABOVE RECOMMENDED EROSION CONTROL MEASURES WILL EROSION IT IS IMPERATIVE THAT THE SLOPES, ONCE PREPARED, REMAIN UNDISTURBED UNTIL SEEDING COMMENCES.


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GENERAL NOTES
FIELD VERIFICATION OF QUANTITIES SHALL BE THE
RESPONSIBILITY OF THE CONTRACTOR. DISTURBED AREAS ON REVEGETATION PLAN ARE SCHEMATIC.

REVEGETATION SUMMARY


AREA TO BE HYDROSEEDED 302,828 SF ± (6.95 AC ±)




RIDGELINE VISTAS SUBDIVISION PRELIMINARY ENGINEERING AND REVEGETATION PLAN CANYON COUNTY, IDAHO

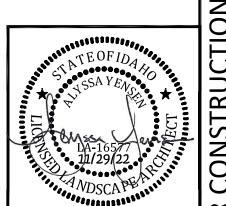REVISIONS			
ITEM	DATE		
AGENCY COMMENTS	2/2/22		
AGENCY COMMENTS	6/1/22		
BUILDABLE PARCEL REVISION	11/29/22		
	ITEM AGENCY COMMENTS AGENCY COMMENTS		



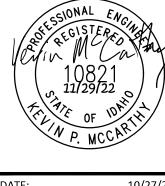

10/27/21 18-168

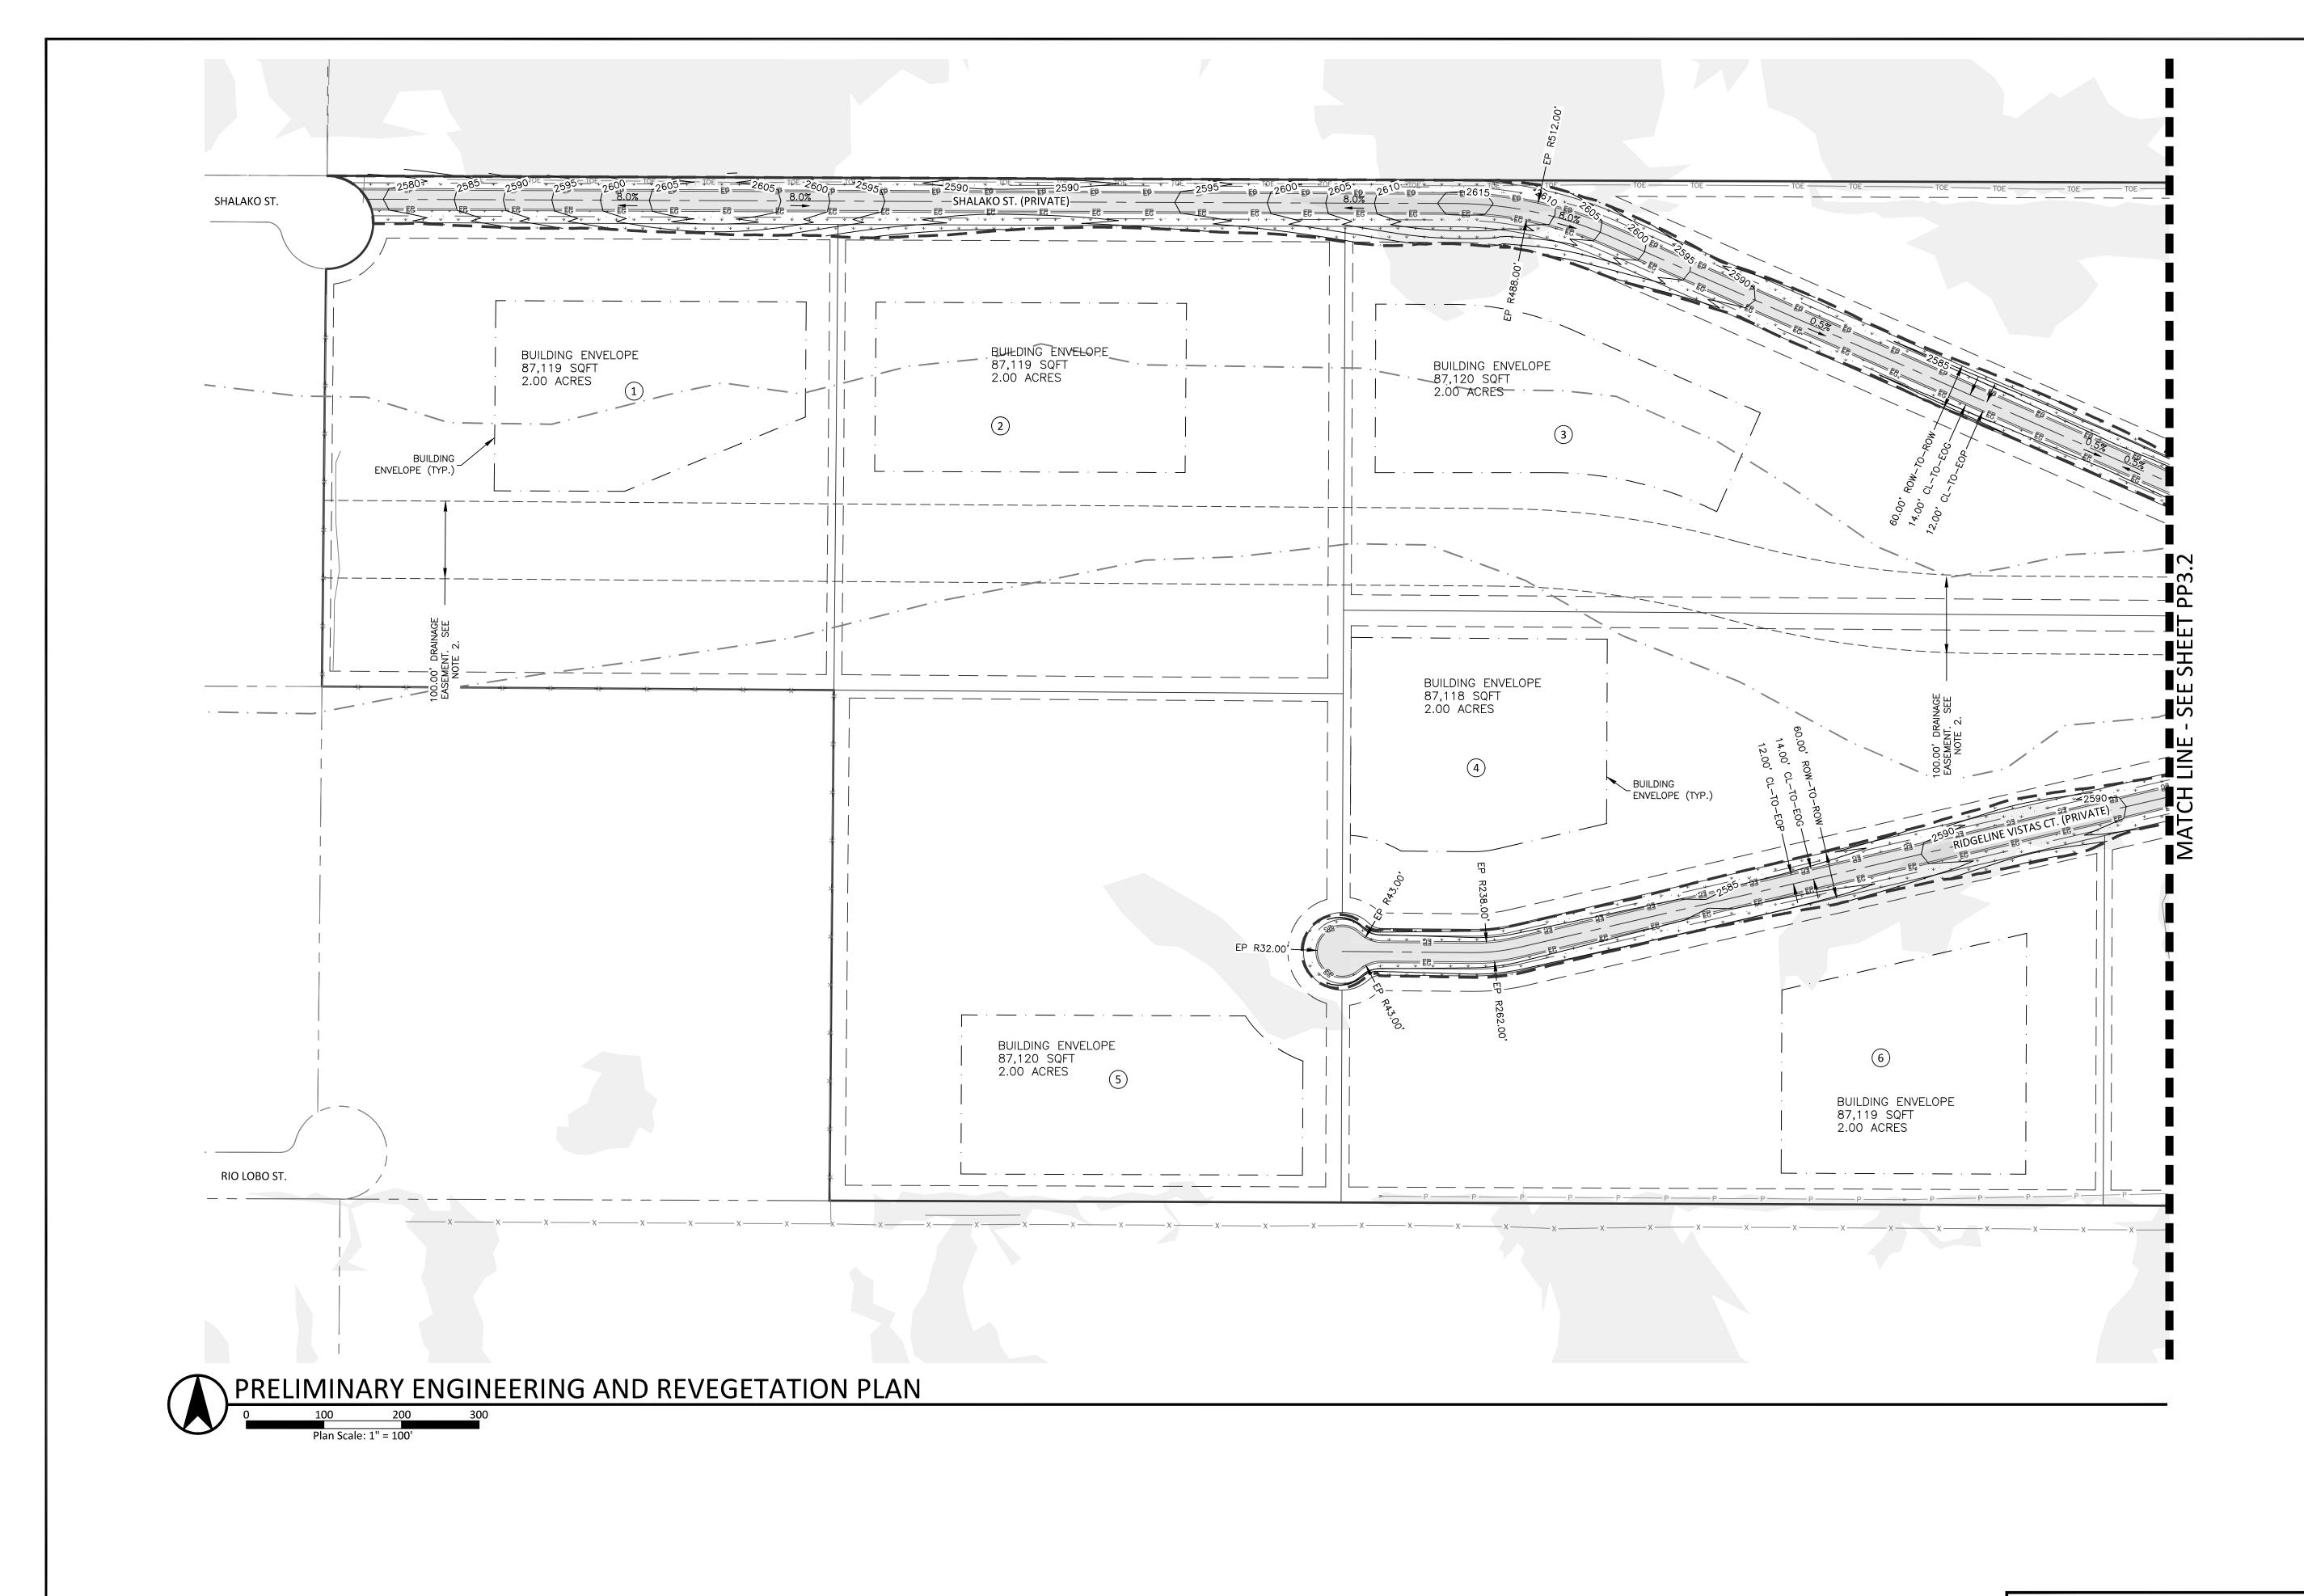

GENERAL NOTES

1. FIELD VERIFICATION OF QUANTITIES SHALL BE THE RESPONSIBILITY OF THE CONTRACTOR. DISTURBED AREAS ON REVEGETATION PLAN ARE SCHEMATIC.

2. A 100' DRAINAGE EASEMENT SHALL BE PROVIDED TO PRESERVE EXISTING DRAINAGE CORRIDORS. THIS EASEMENT IS SUBJECT TO CHANGE DURING FINAL DESIGN.

GRADING LEGEND

CRADING LEGEND

2900 FINISHED GRADE CONTOUR

CRADE BREAK

GRADE BREAK

LIMITS OF GRADING

AREA TO BE
HYDROSEEDED

RIDGELINE VISTAS SUBDIVISION

PRELIMINARY ENGINEERING AND REVEGETATION PLAN

CANYON COUNTY, IDAHO

REVISIONS

ITEM DATE


AGENCY COMMENTS 2/2/22

AGENCY COMMENTS 6/1/22


BUILDABLE PARCEL REVISION 11/29/22



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DATE: 10/27/21
PROJECT: 18-168
SHEET NO.
PP3.1

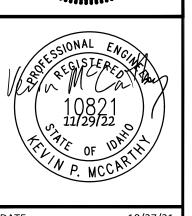

GENERAL NOTES

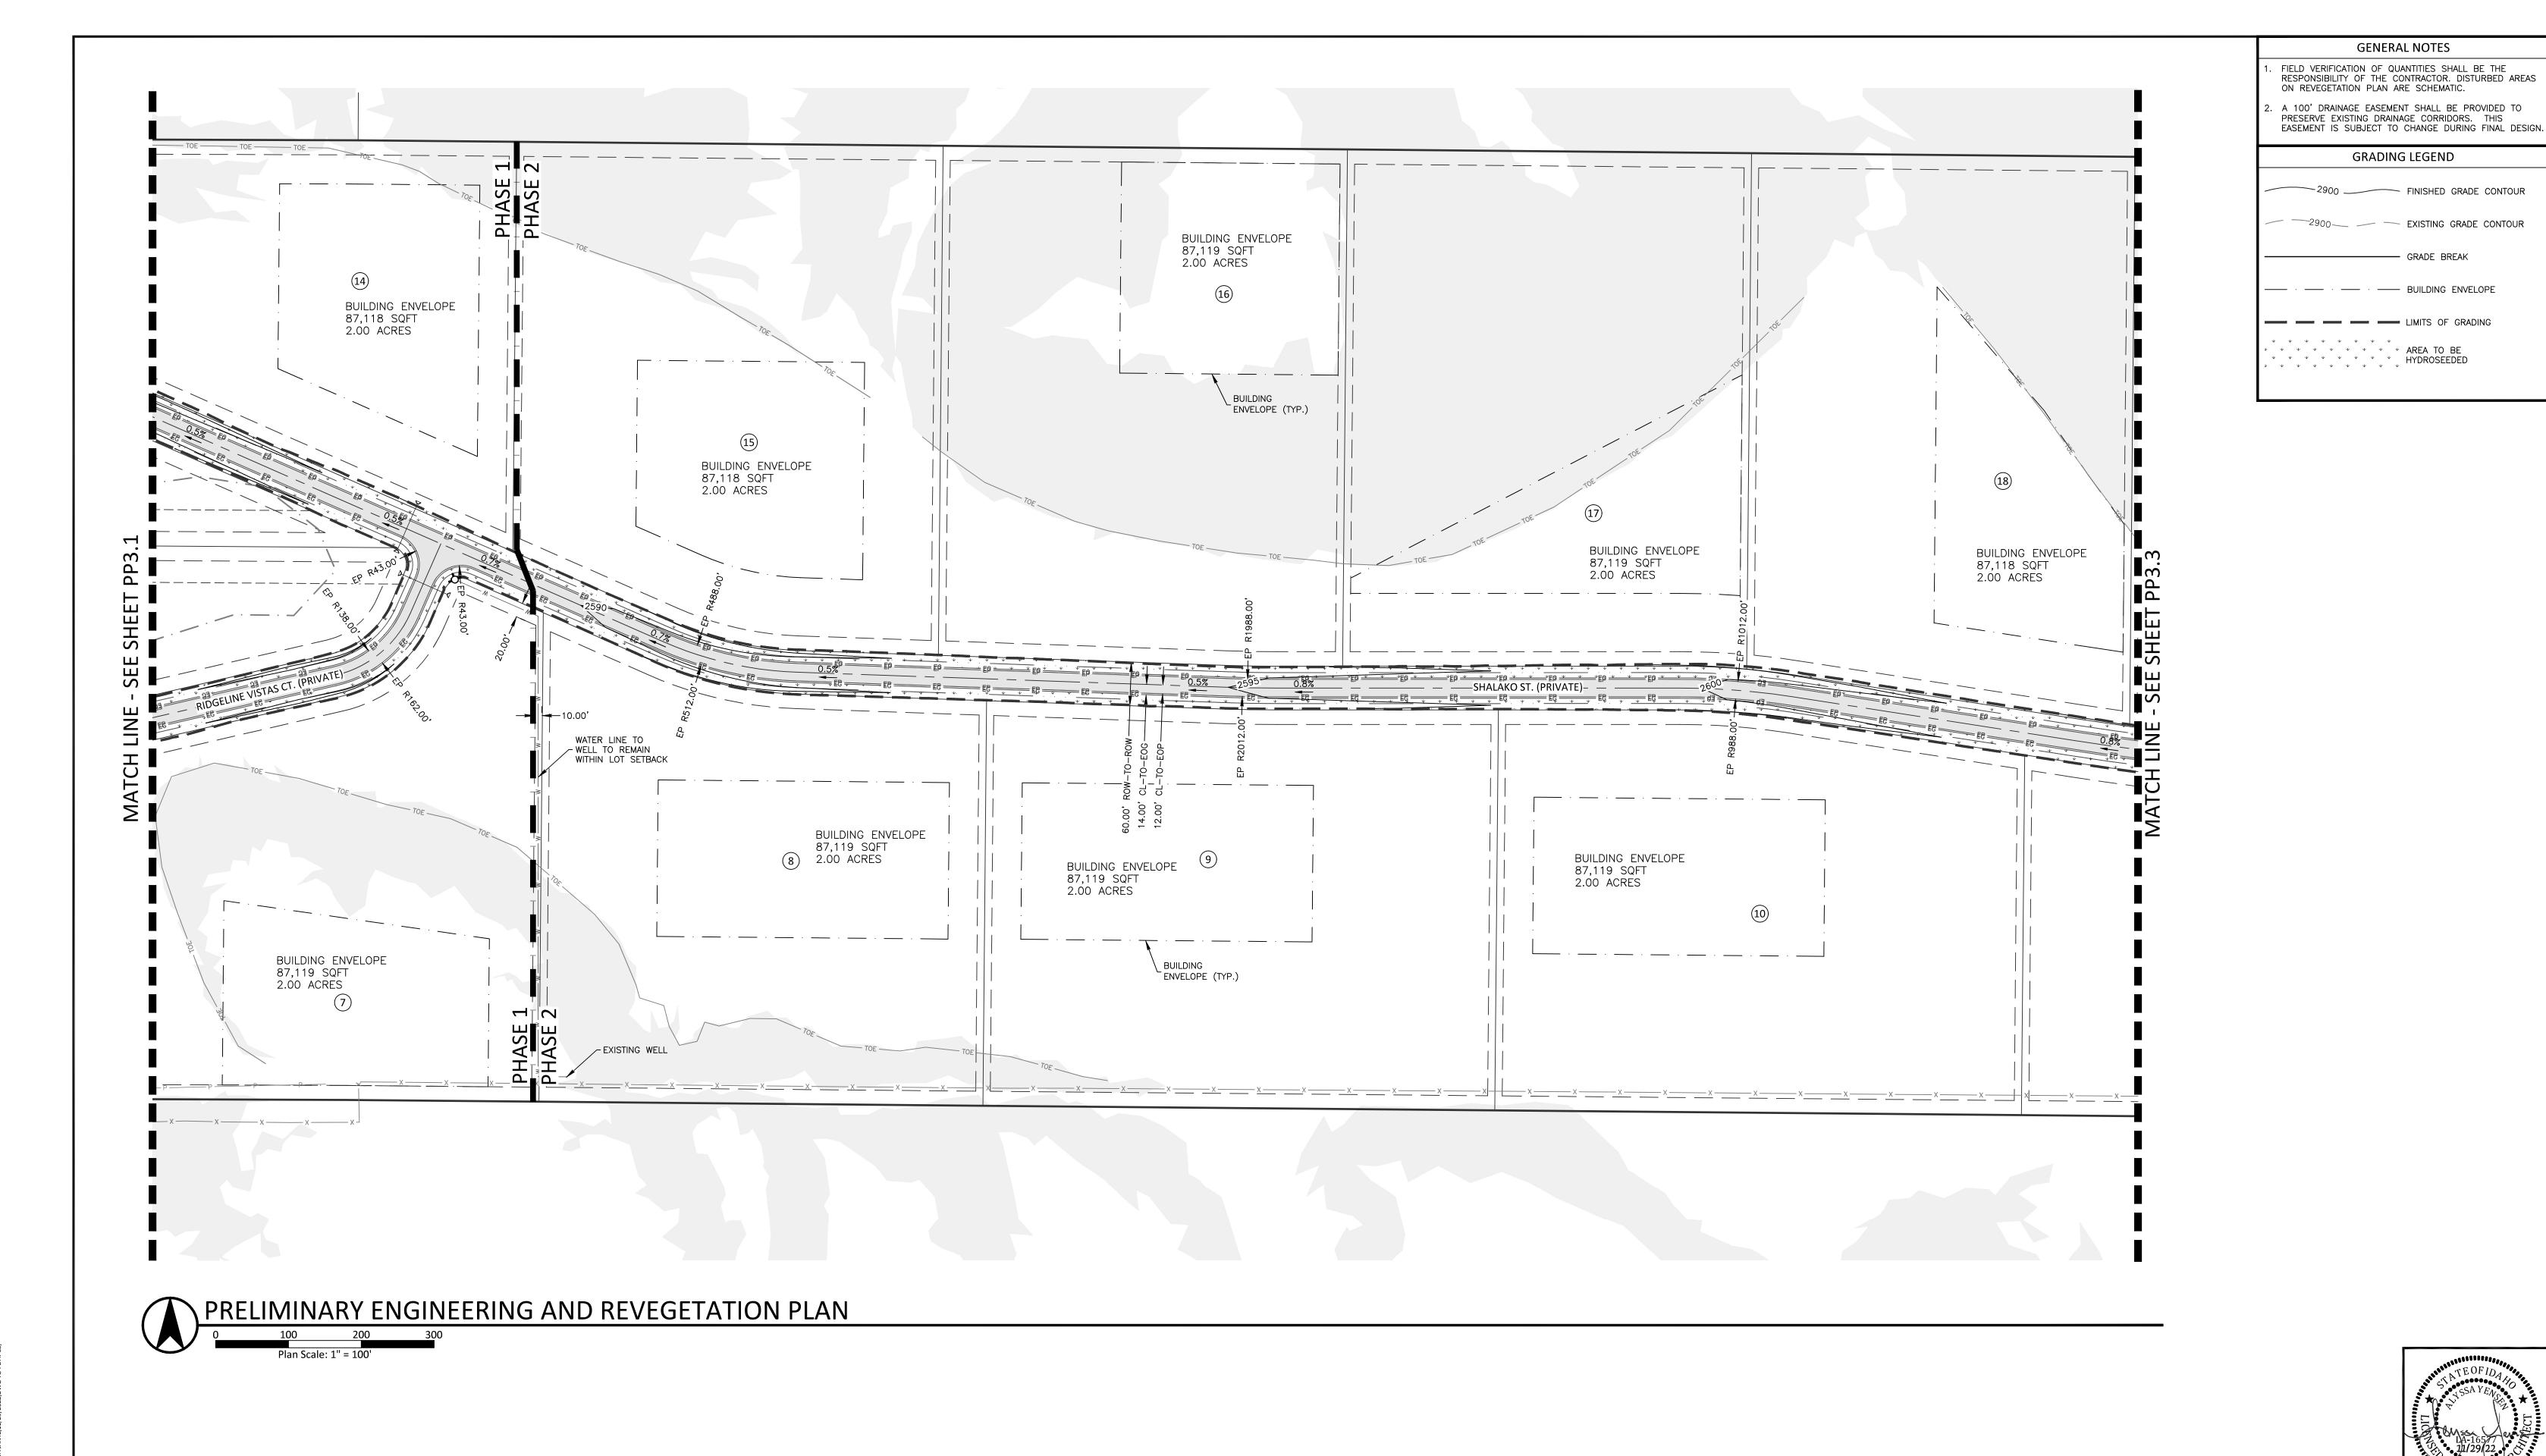GRADING LEGEND

---- · ---- BUILDING ENVELOPE


--- GRADE BREAK

RIDGELINE VISTAS SUBDIVISION PRELIMINARY ENGINEERING AND REVEGETATION PLAN CANYON COUNTY, IDAHO

	REVISIONS	
Ю.	ITEM	DATE
	AGENCY COMMENTS	2/2/22
	AGENCY COMMENTS	6/1/22
3	BUILDABLE PARCEL REVISION	11/29/22

ENGINEERING
5725 NORTH DISCOVERY WAY
BOISE, IDAHO 83713
PHONE (208) 639-6939
kmengllp.com

PP3.2

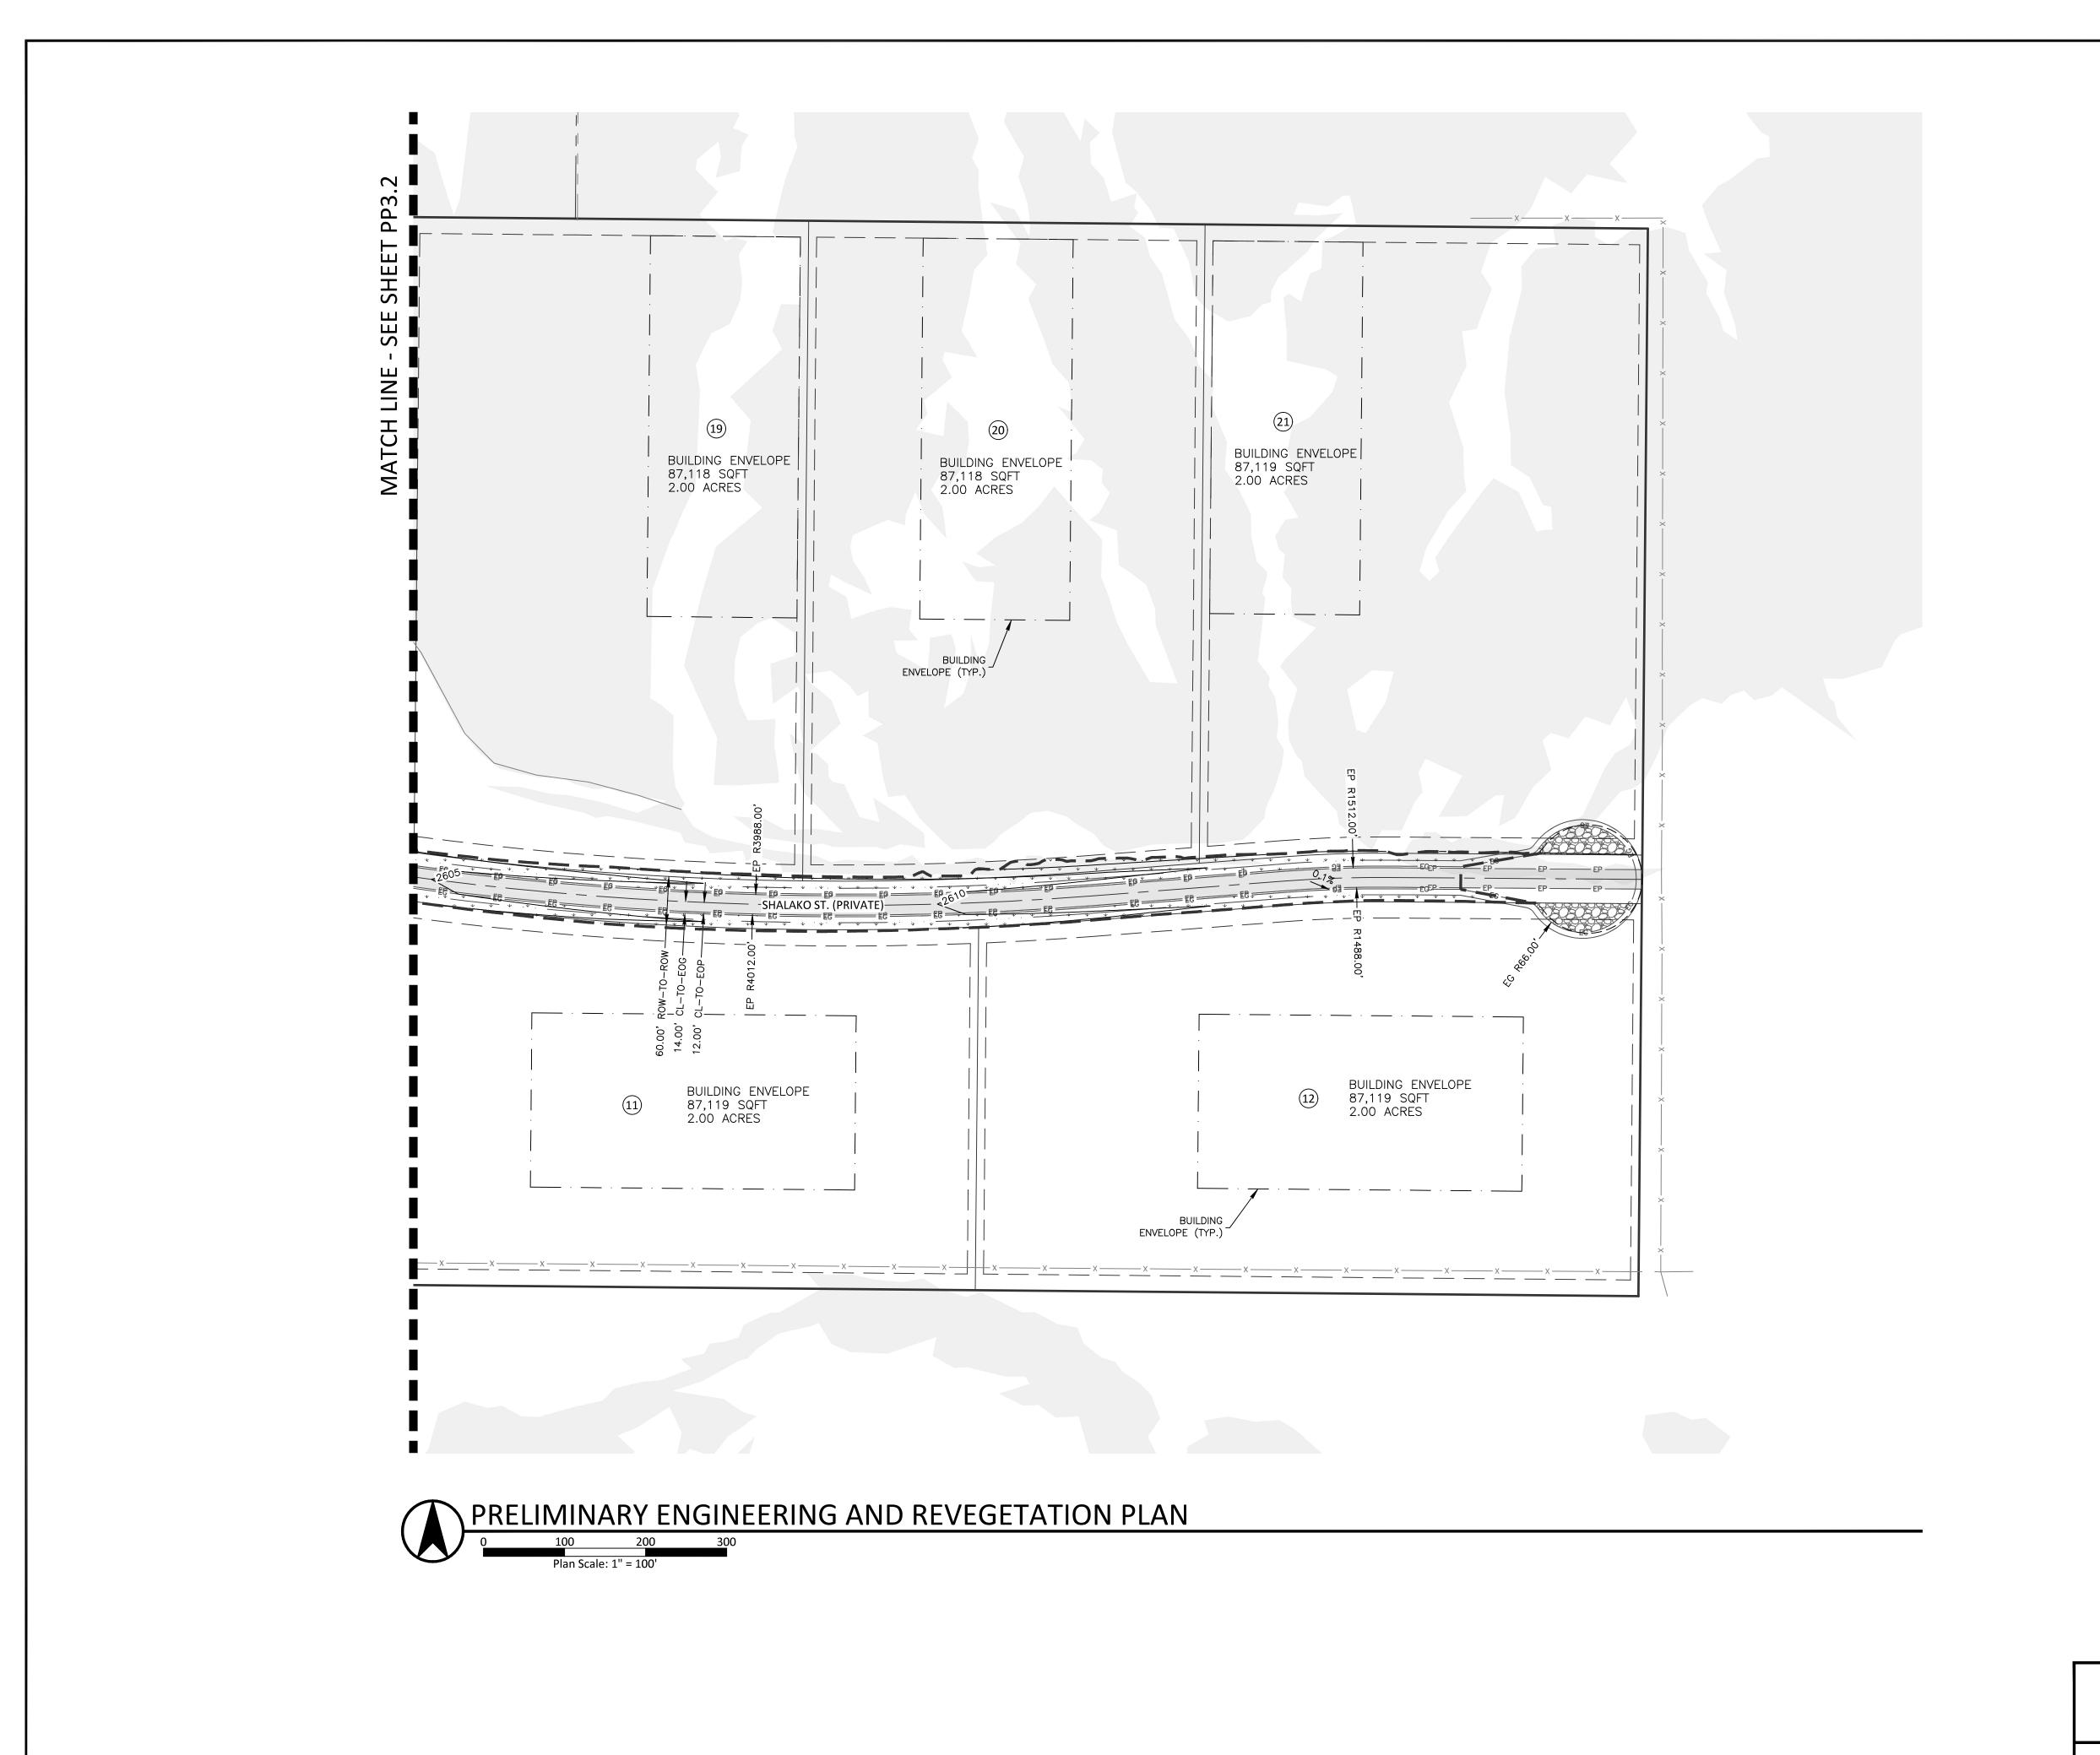

GENERAL NOTES

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GRADING LEGEND

2900 FINISHED GRADE CONTOUR

2900 EXISTING GRADE CONTOUR

GRADE BREAK

BUILDING ENVELOPE

LIMITS OF GRADING


AREA TO BE HYDROSEEDED

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RIDGELINE VISTAS SUBDIVISION PRELIMINARY ENGINEERING AND REVEGETATION PLAN CANYON COUNTY, IDAHO

REVISIONS			
NO.	ITEM	DATE	
1	AGENCY COMMENTS	2/2/22	
2	AGENCY COMMENTS	6/1/22	
3	BUILDABLE PARCEL REVISION	11/29/22	

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	ENGINEERING 5725 NORTH DISCOVERY WAY BOISE, IDAHO 83713 PHONE (208) 639-6939 kmengllp.com	S

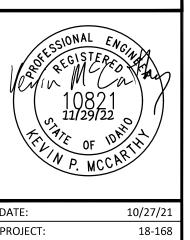

PROJECT: 18-168
SHEET NO.
PP3.3



November 29, 2022 Project No. 18-168

Mr. Dan Lister
Planning Official
Canyon County Development Services
111 North 11th Avenue
Caldwell, Idaho 83605

RE: Ridgeline Vistas Subdivision – Canyon County Revised Preliminary Plat

Dear Mr. Lister:

On behalf of Ridgeline Vistas, LLC, we are pleased to submit the attached revisions to the preliminary plat including changes per comments received, an in-person meeting with Devin Krasowski and Stephanie Hailey on October 6th, and subsequent correspondence via email. A summary of revised items and information included is listed below.

- The preliminary plat has been revised to include two phases to accommodate timing of future development. The first phase is comprised of Lots 1-7 & Lot 14, Block 1, a portion of Shalako Street, and Ridgeline Vistas Court. The second phase will include Lots 8-12 & Lots 15-21, Block 1 and the remainder of Shalako Street.
- Revised building envelopes have been depicted on the revised preliminary plat to coincide with the flood study completed by HDR, dated September 23, 2022. As required by Canyon County, the flood study evaluated the 100-year flood inundation limits to determine preliminary base flood elevations for the project area. The results of the study determined that this area would have minimal risk of flooding with flow depths typically less than one foot. Therefore, this area will be proposed as a shaded Zone X SFHA with our LOMR application. A LOMR application is in the process of being submitted to FEMA. Due to this anticipated change in the floodplain designation, the building envelopes were adjusted on several lots in Phase 1.
- A 100' drainage easement has been included within Phase 1 of the development to accommodate a drainage corridor for stormwater runoff.
- Drainage culverts have been added to the Intersection of Ridgeline Vistas Court and Shalako Street to accommodate stormwater runoff from the roadway and adjacent lots.

Should you have questions or require further information in order to process this application, please feel free to contact me.

Sincerely,

KM Engineering, LLP

Kevin McCarthy, P.E.


Principal


cc: Ridgeline Vistas, LLC


Mr. Matt Drown

PRELIMINARY PLAT SHOWING RIDGELINE VISTAS SUBDIVISION

THE S 1/2 OF THE SW 1/4 AND THE SW 1/4 OF THE SE 1/4 OF SECTION 5, AND A PORTION OF THE S 1/2 OF THE SE 1/4 OF SECTION 6, TOWNSHIP 5 NORTH, RANGE 2 WEST, BOISE MERIDIAN, CANYON COUNTY, IDAHO

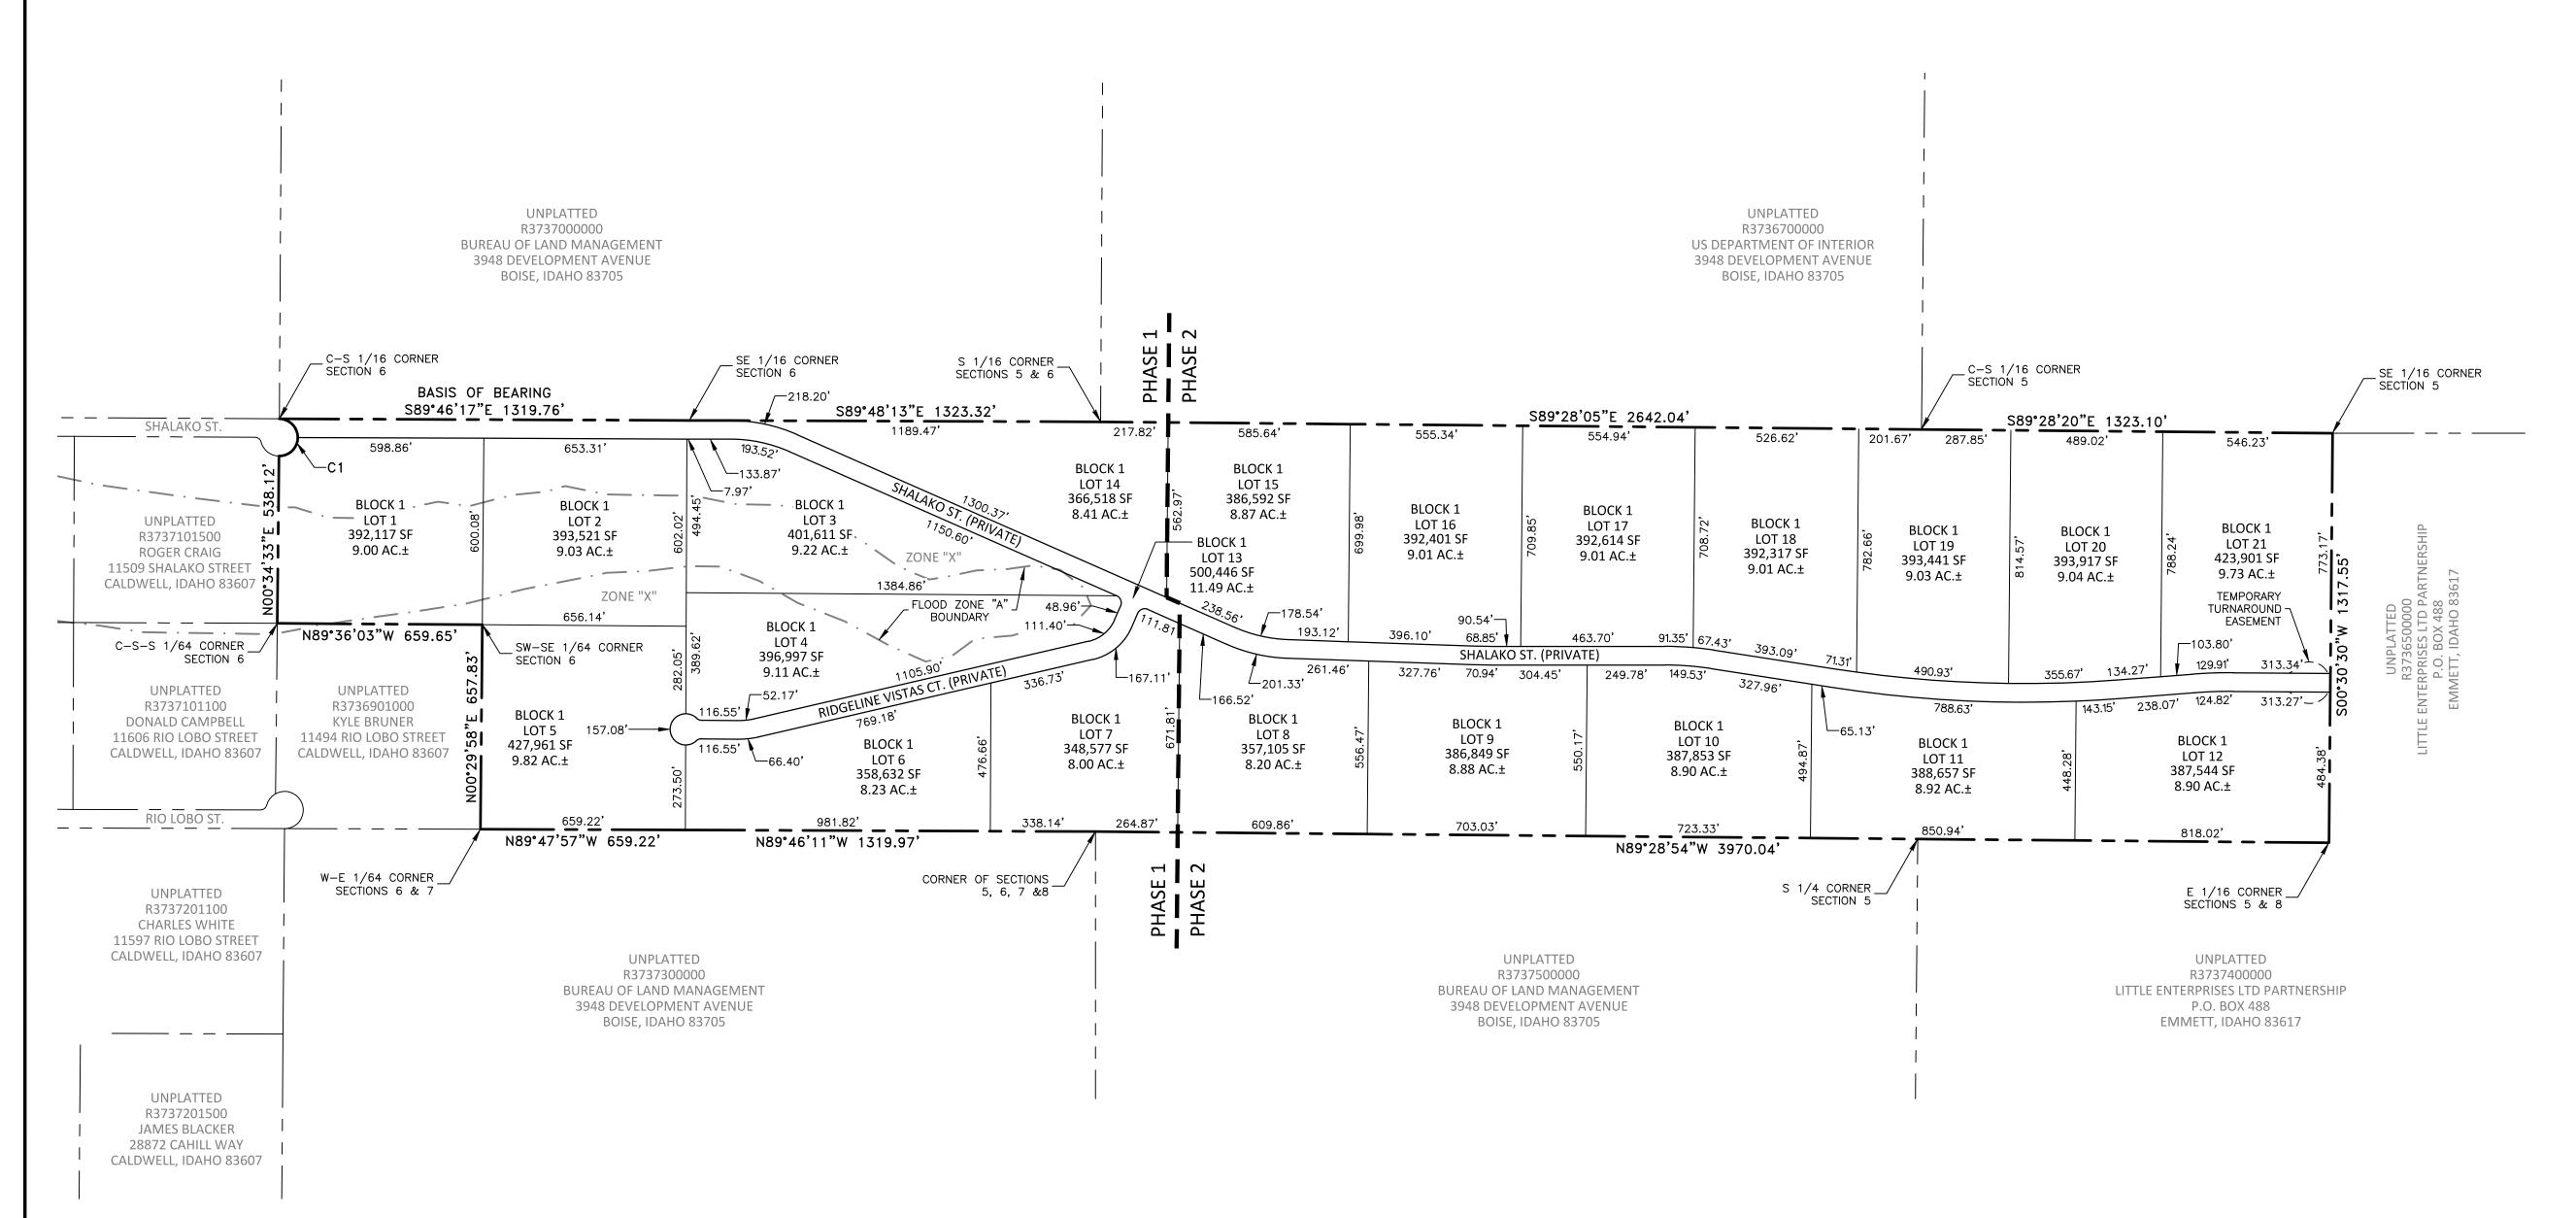

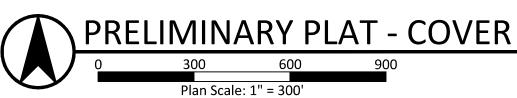

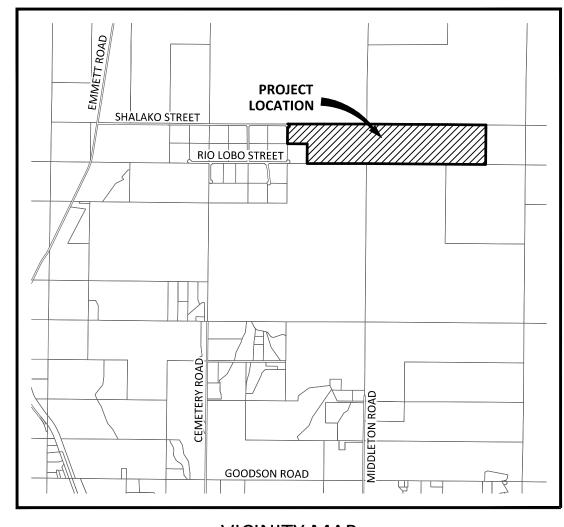

VICINITY MAP

R3736900000 & R3736800000

(CONDITIONAL RURAL RESIDENTIAL)

O SHALAKO STREET CALDWELL, IDAHO 83607

CR-R-R

PRELIMINARY PLAT DATA

PARCEL NUMBER(S)

PROPERTY ADDRESS: CITY/STATE/ZIP:

CURRENT ZONING: PROJECT AREA:

MINIMUM LOT SIZE:

AVERAGE LOT SIZE:

SETBACK DATA

±189.84 ACRES DEVELOPABLE LOTS: ±178.35 ACRES COMMON LOT (PRIVATE ROADWAY): ±11.49 ACRES 9.83 ACRES MAXIMUM LOT SIZE:

8.00 ACRES 8.92 ACRES 0.11 UNITS PER ACRE

NUMBER OF LOTS DEVELOPABLE LOTS: COMMON LOT (PRIVATE ROADWAY): TOTAL NUMBER OF LOTS:

EASEMENT DATA (GENERAL UTILITY EASEMENT)

10 FEET 10 FEET FRONT AND REAR:

FRONT & REAR

PRELIMINARY PLAT NOTES

1. THE HOMEOWNER'S ASSOCIATION, UNDERLYING PROPERTY OWNER OR ADJACENT PROPERTY OWNER IS RESPONSIBLE FOR ALL STORM DRAINAGE FACILITIES OUTSIDE THE PUBLIC RIGHT-OF-WAY, INCLUDING ALL ROUTINE AND HEAVY MAINTENANCE.

10 FEET 20 FEET

2. AS SHOWN HEREON, A PORTION OF THIS PLAT IS LOCATED WITHIN ZONE A, PER FLOOD INSURANCE RATE MAP, PANEL 150 OF575, MAP NUMBER 16027C0150F, DATED MAY 24, 2011. A FLOOD STUDY AND LOMR APPLICATION IS IN THE PROCESS OF BEING COMPLETED FOR THIS PROPERTY. THE STUDY IS EXPECTED TO GIVE THIS AREA A ZONE "X" DESIGNATION AND BE APPROVED PRIOR TO THE FINAL PLAT

3. LOT 13, BLOCK 1 IS A COMMON LOT FOR THE PURPOSE OF A PRIVATE ROAD WHAT SHALL BE OWNED AND MAINTAINED BY THE HOMEOWNER'S ASSOCIATION OR ASSIGNS.

SURVEY CONTROL NOTES

1. ALL SURVEY DATA IS BASED ON THE NAD83 STATE PLANE COORDINATE SYSTEM (IDAHO WEST 1103) AND NAVD 88 VERTICAL DATUM.

INDEX OF DRAWINGS

SHEET NO.	SHEET TITLE	
PP1.0	COVER SHEET	
PP2.0	EXISTING CONDITIONS	
PP3.0	PRELIMINARY ENGINEERING & REVEGETATION F	PLAN
PP3.1	PRELIMINARY ENGINEERING & REVEGETATION F	PLAN
PP3.2	PRELIMINARY ENGINEERING & REVEGETATION I	PLAN
P3.3	PRELIMINARY ENGINEERING & REVEGETATION F	PLAN
	PP1.0 PP2.0 PP3.0 PP3.1 PP3.2	PP1.0 COVER SHEET PP2.0 EXISTING CONDITIONS PP3.0 PRELIMINARY ENGINEERING & REVEGETATION PP3.1 PRELIMINARY ENGINEERING & REVEGETATION PP3.2 PRELIMINARY ENGINEERING & REVEGETATION

PROJECT TEAM

PROPERTY OWNER

NAME:	RIDGELINE VISTAS, LLC
CONTACT:	MATT DROWN
ADDRESS:	2150 W. PACIFIC RIDGE
CITY/STATE/ZIP:	EAGLE, IDAHO 83616
PHONE:	208.867.5309

ENGINEERING

NAME:	KM ENGINEERING, LLP.
CONTACT:	KEVIN McCARTHY, P.E.
ADDRESS:	5725 N. DISCOVERY WAY
CITY/STATE/ZIP:	BOISE, IDAHO 83713
PHONE:	208.639.6939
EMAIL:	kevin@kmengllp.com


LEGEND		
— BOUNDARY LINE	BLOCK #	BLOCK NUMBER
ADJACENT BOUNDARY	LINE #	LOT NUMBER
ROAD CENTERLINE	(R-R)	ZONING
SECTION LINE	, ,	
LOT LINE		EXISTING SLOPES GREATER THAN 15%
	L· . — · . — · . 7	BUILDABLE AREA


— — — SETBACK LINE

RIDGELINE VISTAS SUBDIVISION PRELIMINARY PLAT CANYON COUNTY, IDAHO

REVISIONS		
ITEM	DATE	
AGENCY COMMENTS	2/2/22	
AGENCY COMMENTS	6/1/22	
AGENCY COMMENTS	11/29/22	ENGINEER
AGENCY COMMENTS	4/21/23	5725 NORTH DISCOVE BOISE, IDAHO 83
		PHONE (208) 639-6
		■ kmengllp.com



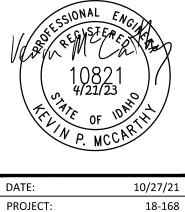

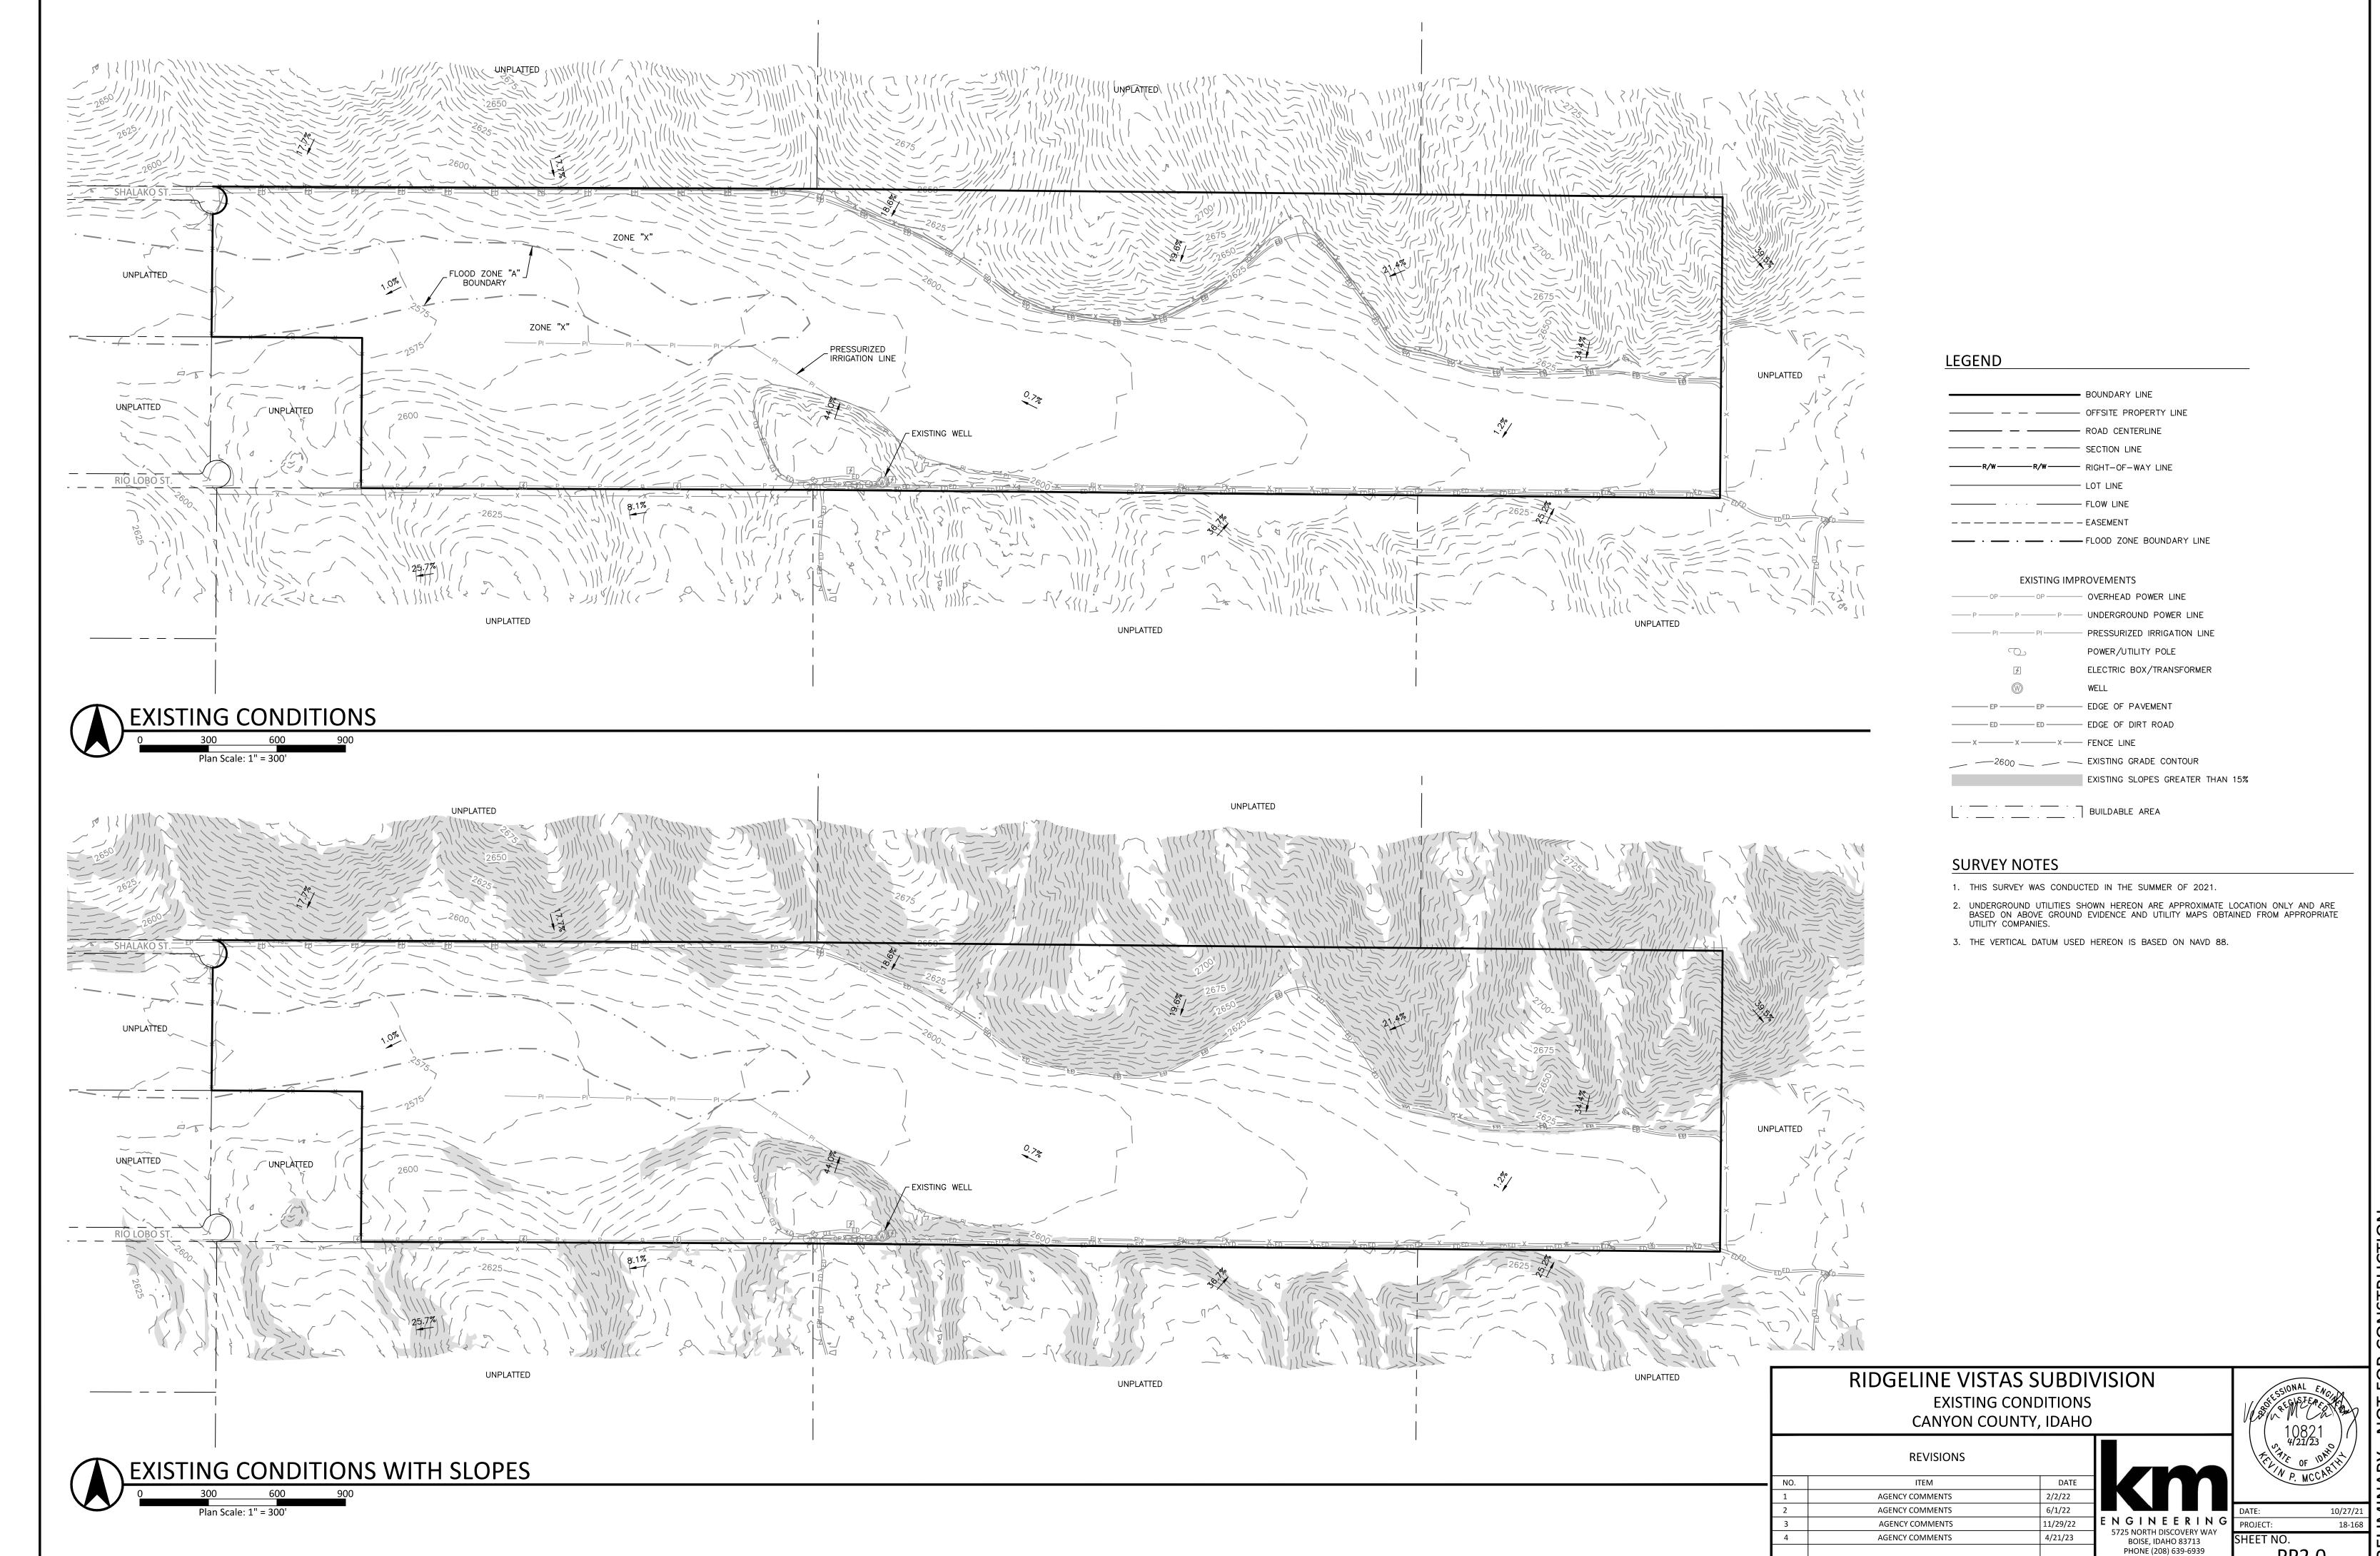


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CENTER-TO-EOP | CENTER-TO-EOP 2% SLOPE └ 3.0" ASPHALT PAVEMENT ROADSIDE BORROW DITCH TYP BOTH SIDES \ 6" OF 3/4"-MINUS CRUSHED AGGREGATE BASE 12" OF PIT RUN OVER COMPACTED

TYPICAL TWO LANE PRIVATE ROAD SECTION

1. STREET SECTION THICKNESS MAY BE REVISED DURING FINAL DESIGN.

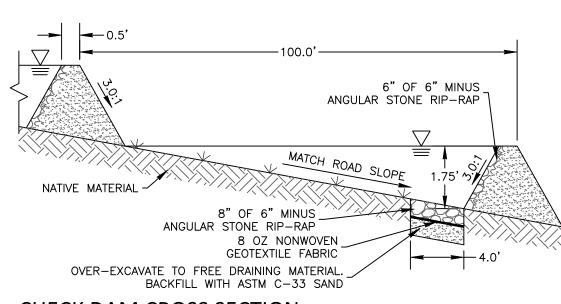

CHECK DAM CROSS SECTION

- 1. CHECK DAMS TO BE CONSTRUCTED OF CLAY SOIL TO MINIMIZE SEEPAGE OR ANGULAR ROCKS FOR CONVEYANCE SWALES.
- 2. SIDE SLOPES AND CHECK DAMS SHALL COMPLY WITH AASHTO CLEAR ZONE GUIDELINES

- 5. ALL STREETS SHALL BE PRIVATE ROADS. ROADWAYS WILL BE CONSTRUCTED TO AT LEAST MINIMUM CANYON COUNTY STANDARDS. SEE THE PRELIMINARY ROADWAY CROSS—SECTION, THIS SHEET.
- 6. STORM DRAINAGE FROM LOT 13, BLOCK 1, THE PRIVATE ROADWAY SHALL BE COLLECTED IN BORROW DITCHES WITHIN THE
- BOUNDARY OF SAID LOT 13, BLOCK 1.
- 7. HISTORIC DRAINAGE FLOW PATTERNS WILL BE MAINTAINED WITH FINAL GRADING.
- 8. ALL EXISTING WELLS ARE APPROXIMATE IN LOCATION AND WILL BE PRESERVED WHERE POSSIBLE. ANY WELL ABANDONMENT SHALL BE COMPLETED IN ACCORDANCE WITH THE REQUIREMENTS OF THE IDAHO DEPARTMENT OF WATER RESOURCES (IDWR) AND IDAHO CODE. THE CONTRACTOR SHALL RETAIN A LICENSED WELL DRILLER FOR ABANDONMENT. COORDINATE WITH ROB WHITNEY AT IDWR WESTERN REGION (334-2190).
- 9. FINISH GRADES AT SUBDIVISION BOUNDARIES SHALL MATCH EXISTING GRADES.
- 10. BORROW DITCHES WILL BE PROTECTED VIA THE USE OF STRAW WADDLES AND CHECK DAMS. IF DAMAGE OCCURS DURING CONSTRUCTION, THE CONTRACTOR SHALL REPAIR THESE FACILITIES AS NEEDED.

RESPONSIBILITY OF THE CONTRACTOR. DISTURBED AREAS ON

EXISTING SLOPES

TOPSOIL DISTRIBUTION
ONCE THE GENERAL EARTHWORK IS COMPLETE AND FINE GRADING HAS BEEN ACCOMPLISHED, THE TOPSOIL SHALL BE REDISTRIBUTED OVER AREAS TO A MINIMUM DEPTH OF FOUR (4) INCHES. WHERE NEEDED, SLOPES SHALL BE GRADED WITH SERRATION TO HOLD THE TOPSOIL ADEQUATELY. THE TOPSOIL SHALL BE SPREAD AND LIGHTLY COMPACTED UTILIZING A BULLDOZER TRACTOR OR OTHER METHOD WITH EQUAL CAPABILITY. IT IS OUR RECOMMENDATION THAT ANY NECESSARY MECHANICAL MEANS OF EROSION CONTROL BE ACCOMPLISHED AS GRADING IS COMPLETED.

REVEGETATION NOTES

<u>EXISTING TOPOGRAPHY & VEGETATION</u> THE AREA TO BE REVEGETATED, AS OUTLINED ON THE PLAN

CONSISTS OF FOOTHILL SLOPES AND RAVINES ASSOCIATED WITH THE BOISE AREA. THE SLOPES TO BE AFFECTED VARY IN DEGREE AND ASPECT. THE EXISTING VEGETATION CONSISTS PRIMARILY OF NATIVE DRYLAND SHRUBS, GRASSES, AND

<u>SITE PREPARATION/ TOPSOIL REMOVAL</u>
THE EARTHWORK PROCESS SHALL BEGIN WITH CLEARING

DISPOSED OF. NATURAL TOPSOIL OCCURS AT VARYING DEPTHS ON THE PROJECT SITE. THE TOPSOIL SHALL BE EXCAVATED AND STOCKPILED AT DESIGNATED STORAGE AREAS

MINIMAL LARGE SHRUBS FROM THE AREAS TO BE DISTURBED WOODY STEMS AND BRANCHES WILL BE CHIPPED ON SITE 1 PROVIDE SOIL TEXTURE IMPROVEMENT, OR REMOVED AND

PRIOR TO THE PROPOSED GRADING OPERATION, SAMPLES OF STOCKPILED SOIL SHALL BE TAKEN AND TESTED FOR SPECIFIC SOIL STRUCTURES AND FERTILITY. TEST RESULTS

WILL BE THE BASIS FOR DETERMINING WHICH, IF ANY, SOIL AMENDMENTS WILL BE NECESSARY TO PROMOTE PLANT

FORBS, AND INTRODUCED WEEDS.

ESTABLISHMENT AND GROWTH.

CONSTRUCTION PLANS.

REVEGETATION SEEDING SHALL FOLLOW IMMEDIATELY AFTER TOPSOIL PLACEMENT AND FINE GRADING IN ORDER TO ELIMINATE SURFACE CRUSTING AND TO FACILITATE BETTER ROOT PENETRATION, THE SURFACE SHALL BE SCARIFIED OR AGAIN "CAT TRACKED" PRIOR TO SEEDING.

SEEDING
DRILL SEEDING TO SLOPES LESS THAN 4:1 AND BROADCAST SEEDING BY HYDROSEEDER FOR GREATER SLOPES SHALL BE USED TO APPLY THE SEED TO THE PROJECT SITE. THE SEED MIX OR MIXES SHALL BE DEFINED ON THE FINAL

HE SEEDING WILL RELY UPON NATURAL PRECIPITATION FOR SEED GERMINATION AND ESTABLISHMENT. MINIMUM GERMINATION OF 90 PERCENT IS REQUIRED. CONTRACTOR SHALL RESEED OR OVERSEED AS NECESSARY TO MEET THIS GERMINATION. TEMPORARY IRRIGATION WILL BE NECESSARY IF THIS GERMINATION IS NOT MET OR IF SEED IS NOT INSTALLED WITHIN NON-IRRIGATED NATIVE SEED RECOMMENDED WINDOW.

NON IRRIGATED NATIVE SEED RECOMMENDED WINDOW:

SPRING SEEDING - AFTER FROST LEAVES GROUND AND TEMPERATURES ARE CONSISTENT ±FEB. 15-MAY 15

FALL SEEDING - AFTER FIRST FROST IN FALL. ±OCTOBER 15- NOVEMBER 15 DO NOT APPLY SEED ON TOP OF

AMENDMENTS AND FERTILIZERS WILL BE ADDED TO THE TOPSOIL AS DETERMINED FROM THE SOIL TESTS, AND ONLY AS NECESSARY.

TO PROVIDE PROTECTIVE SEED COVER, AID IN EROSION CONTROL AND HELP TO RETAIN MOISTURE, A GRASS-FIBER MULCH AND SYNTHETIC TACKIFIER SHALL BE BROADCAST IN A HYDROMULCH PROCESS FOLLOWING SEEDING. THE GRASS-FIBER MULCH IS BROADCAST AT A MINIMUM RATE OF TWO THOUSAND (1,000) POUNDS PER ACRE.

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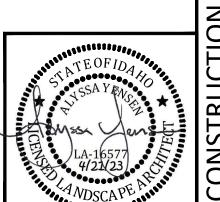
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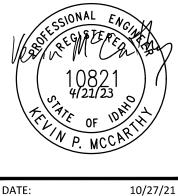
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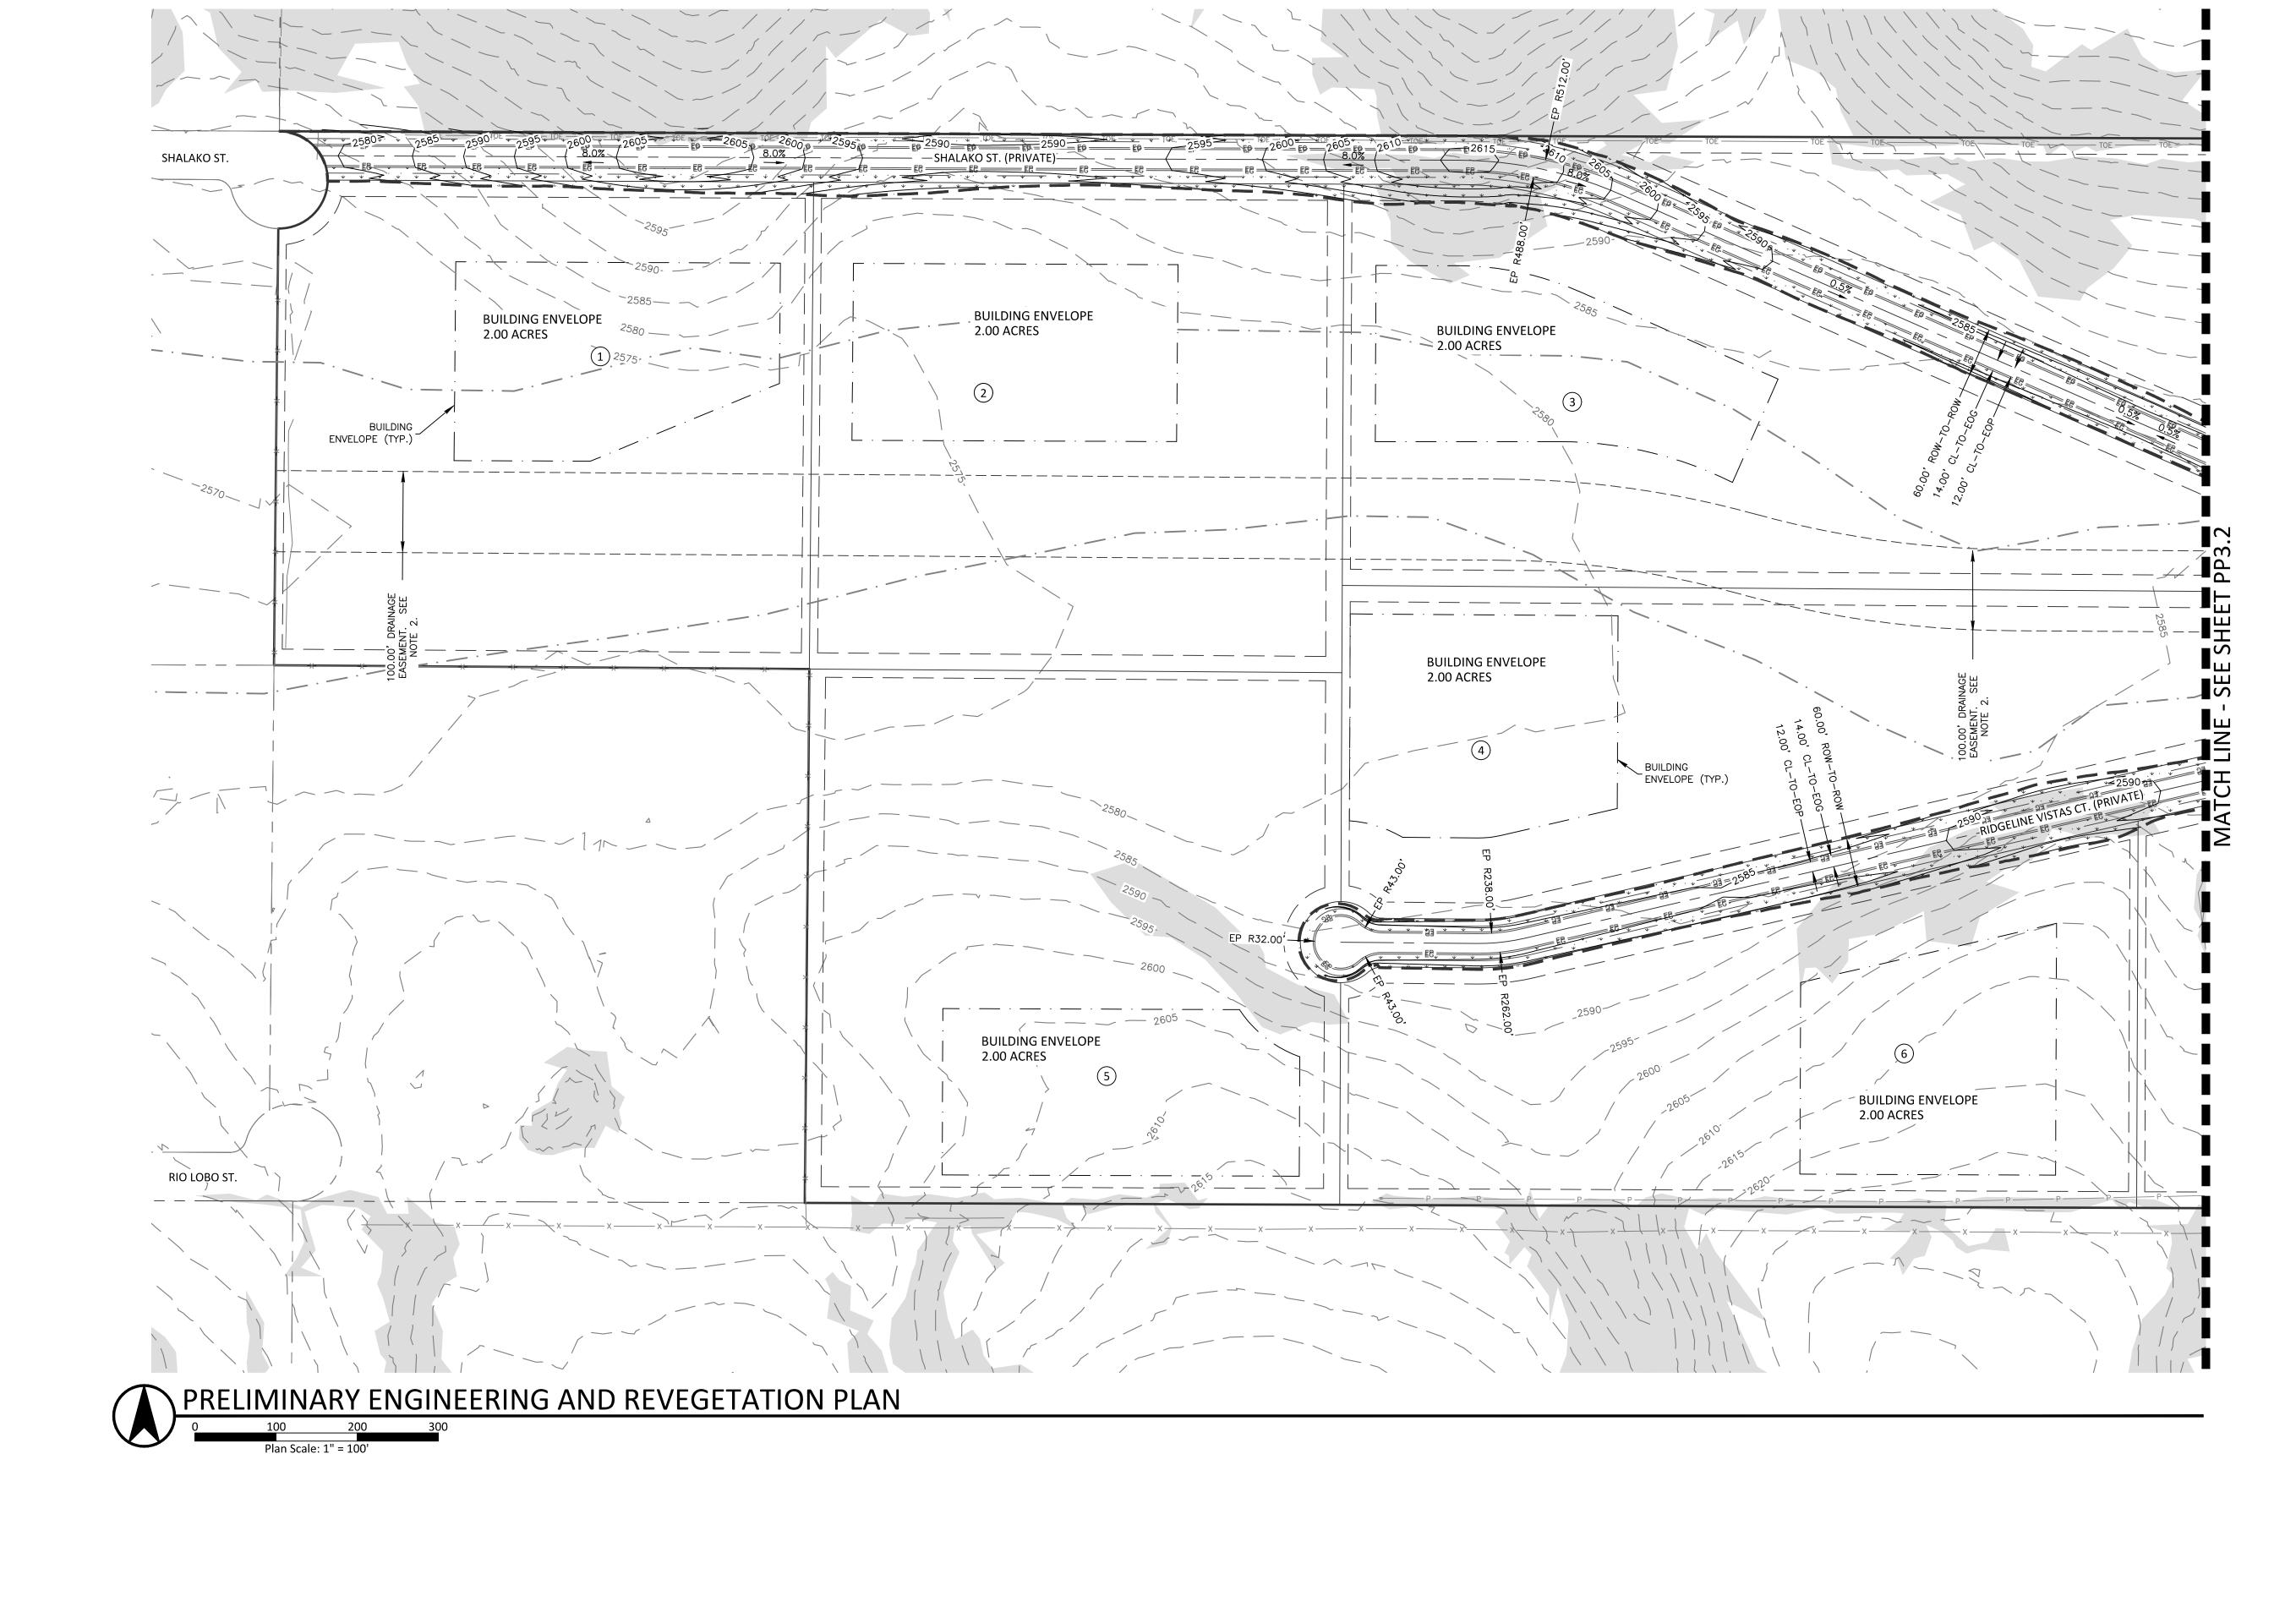
RIDGELINE VISTAS SUBDIVISION PRELIMINARY ENGINEERING AND REVEGETATION PLAN CANYON COUNTY, IDAHO

	REVISIONS	
NO.	ITEM	DATE
1	AGENCY COMMENTS	2/2/22
2	AGENCY COMMENTS	6/1/22
3	AGENCY COMMENTS	11/29/22
4	AGENCY COMMENTS	4/21/23





18-168



GENERAL NOTES

RIDGELINE VISTAS SUBDIVISION

PRELIMINARY ENGINEERING AND REVEGETATION PLAN

CANYON COUNTY, IDAHO

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ITEM DATE

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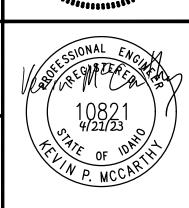
BUILDABLE PARCEL REVISION 11/29/22

AGENCY COMMENTS 4/21/23


BUILDABLE PARCEL REVISION 11/29/22

AGENCY COMMENTS 4/21/23





DATE: 10/27/21
PROJECT: 18-168
SHEET NO.
PP3.1

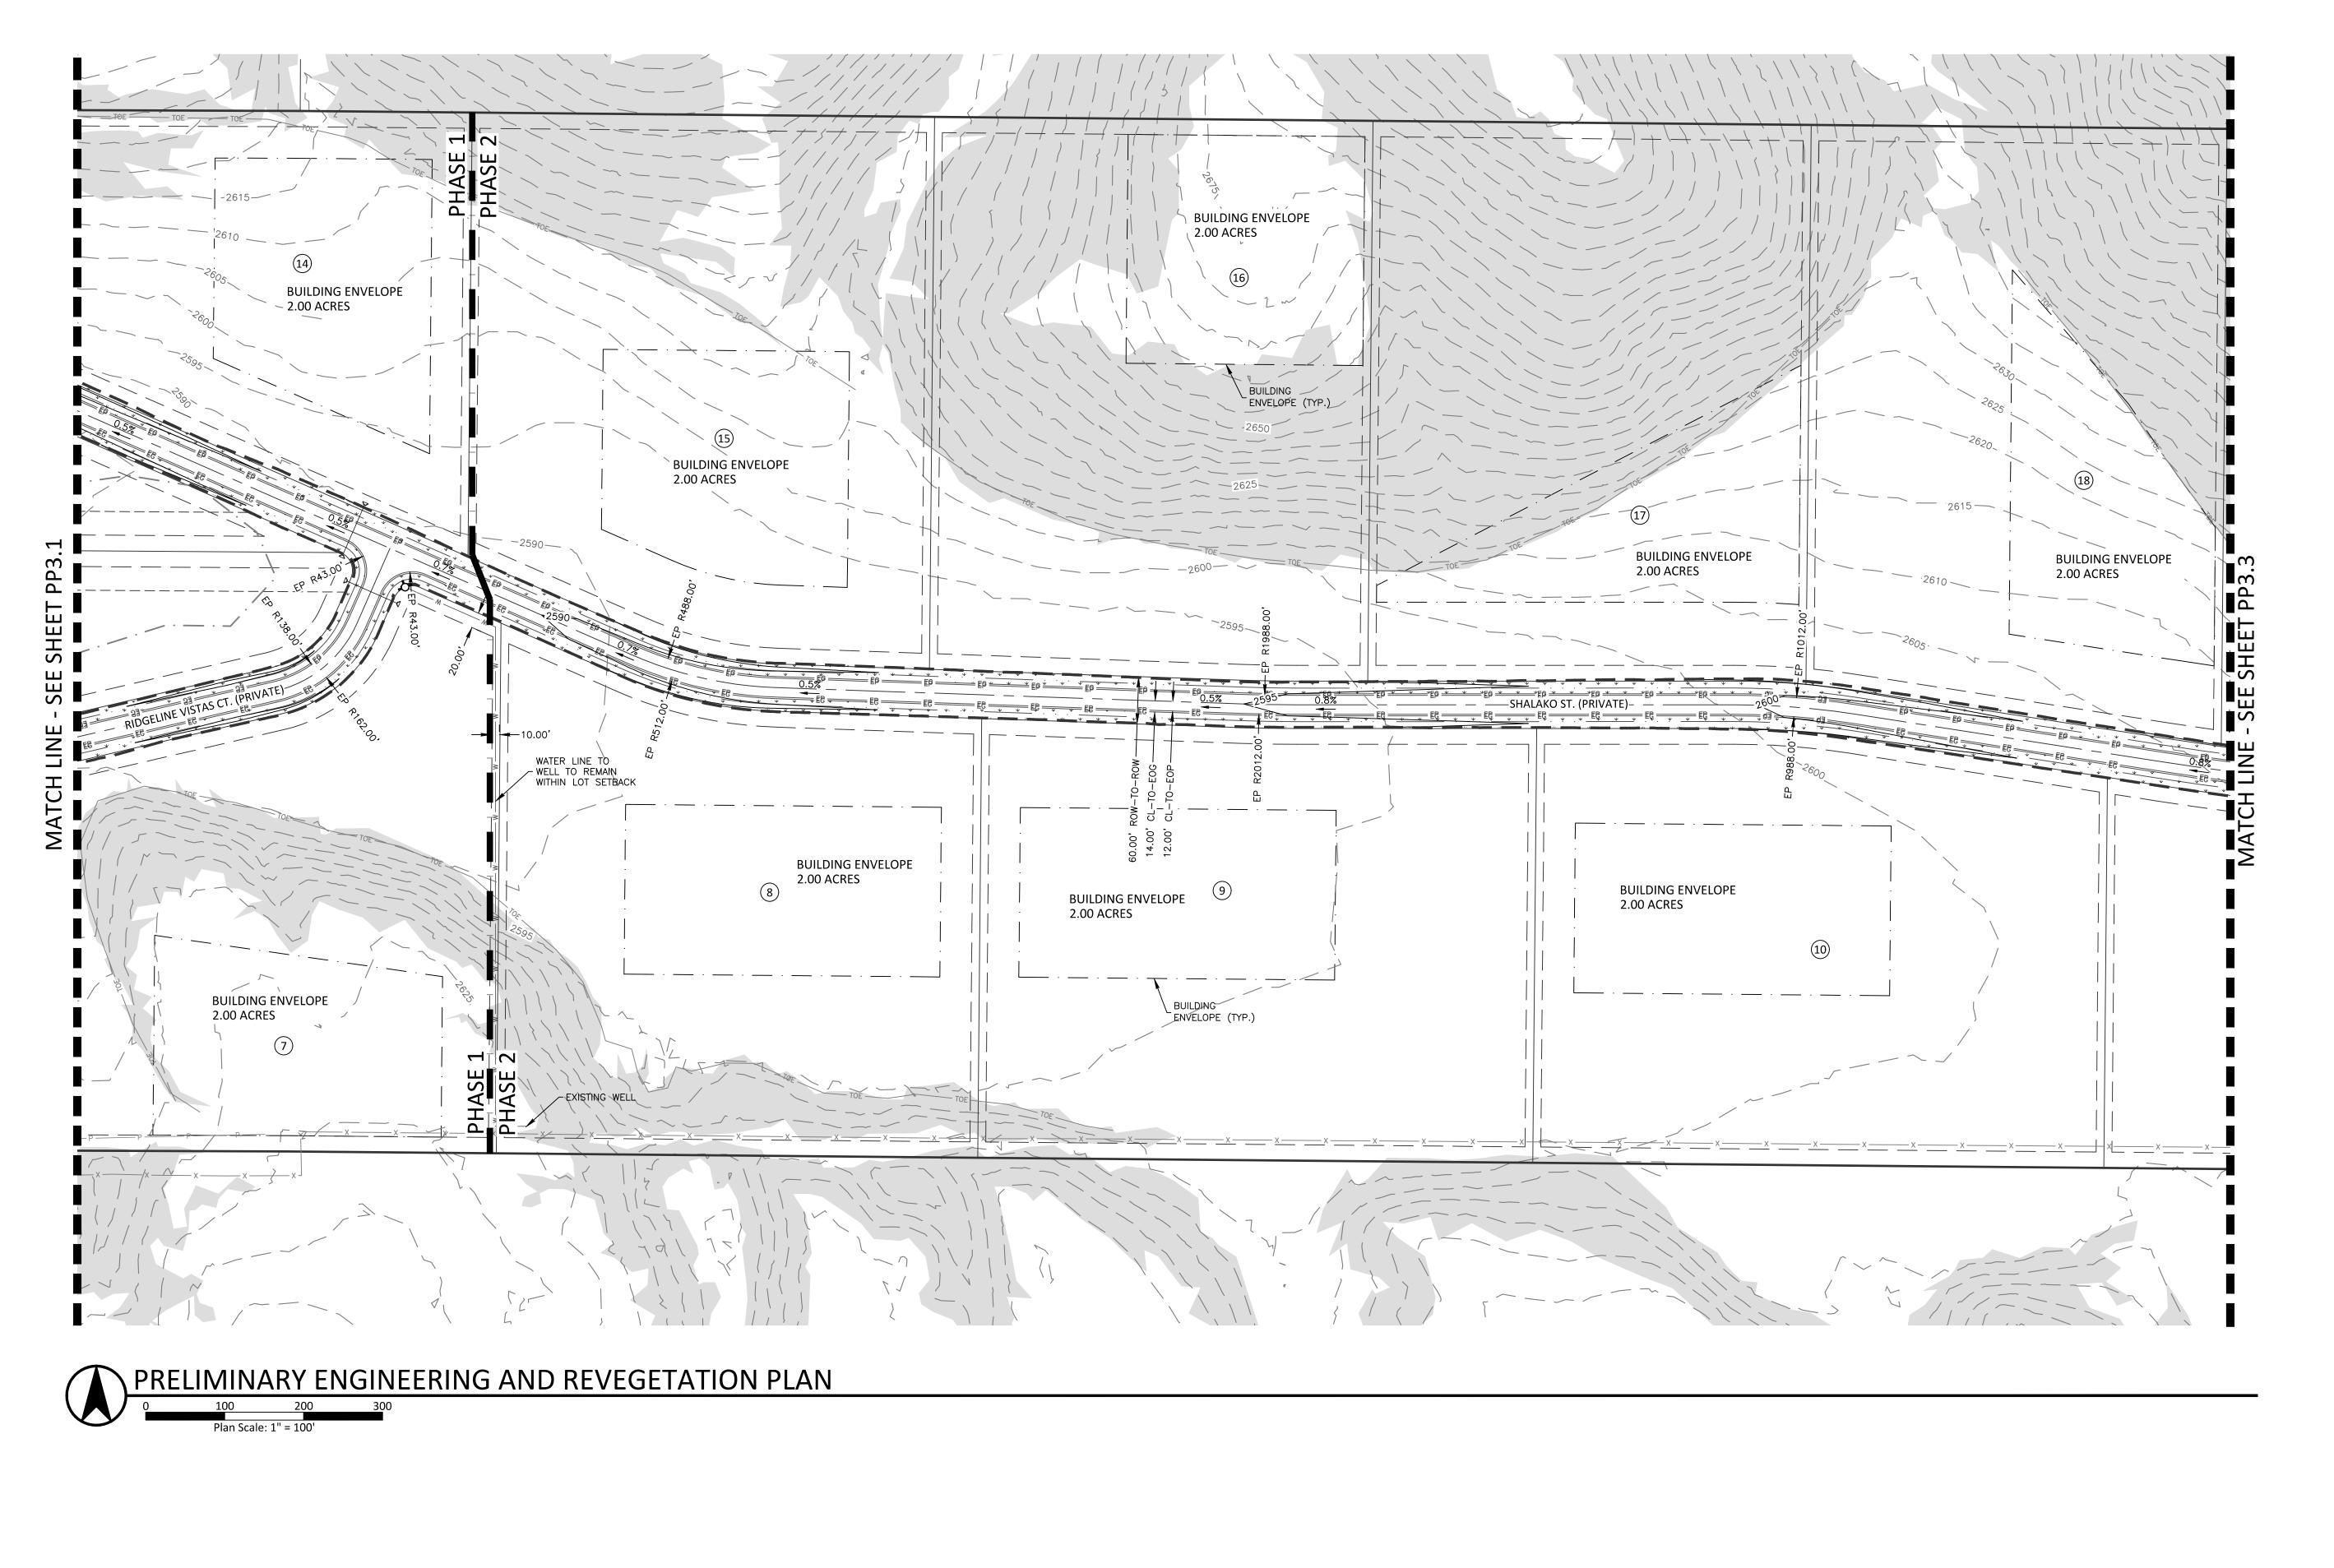

RIDGELINE VISTAS SUBDIVISION PRELIMINARY ENGINEERING AND REVEGETATION PLAN CANYON COUNTY, IDAHO

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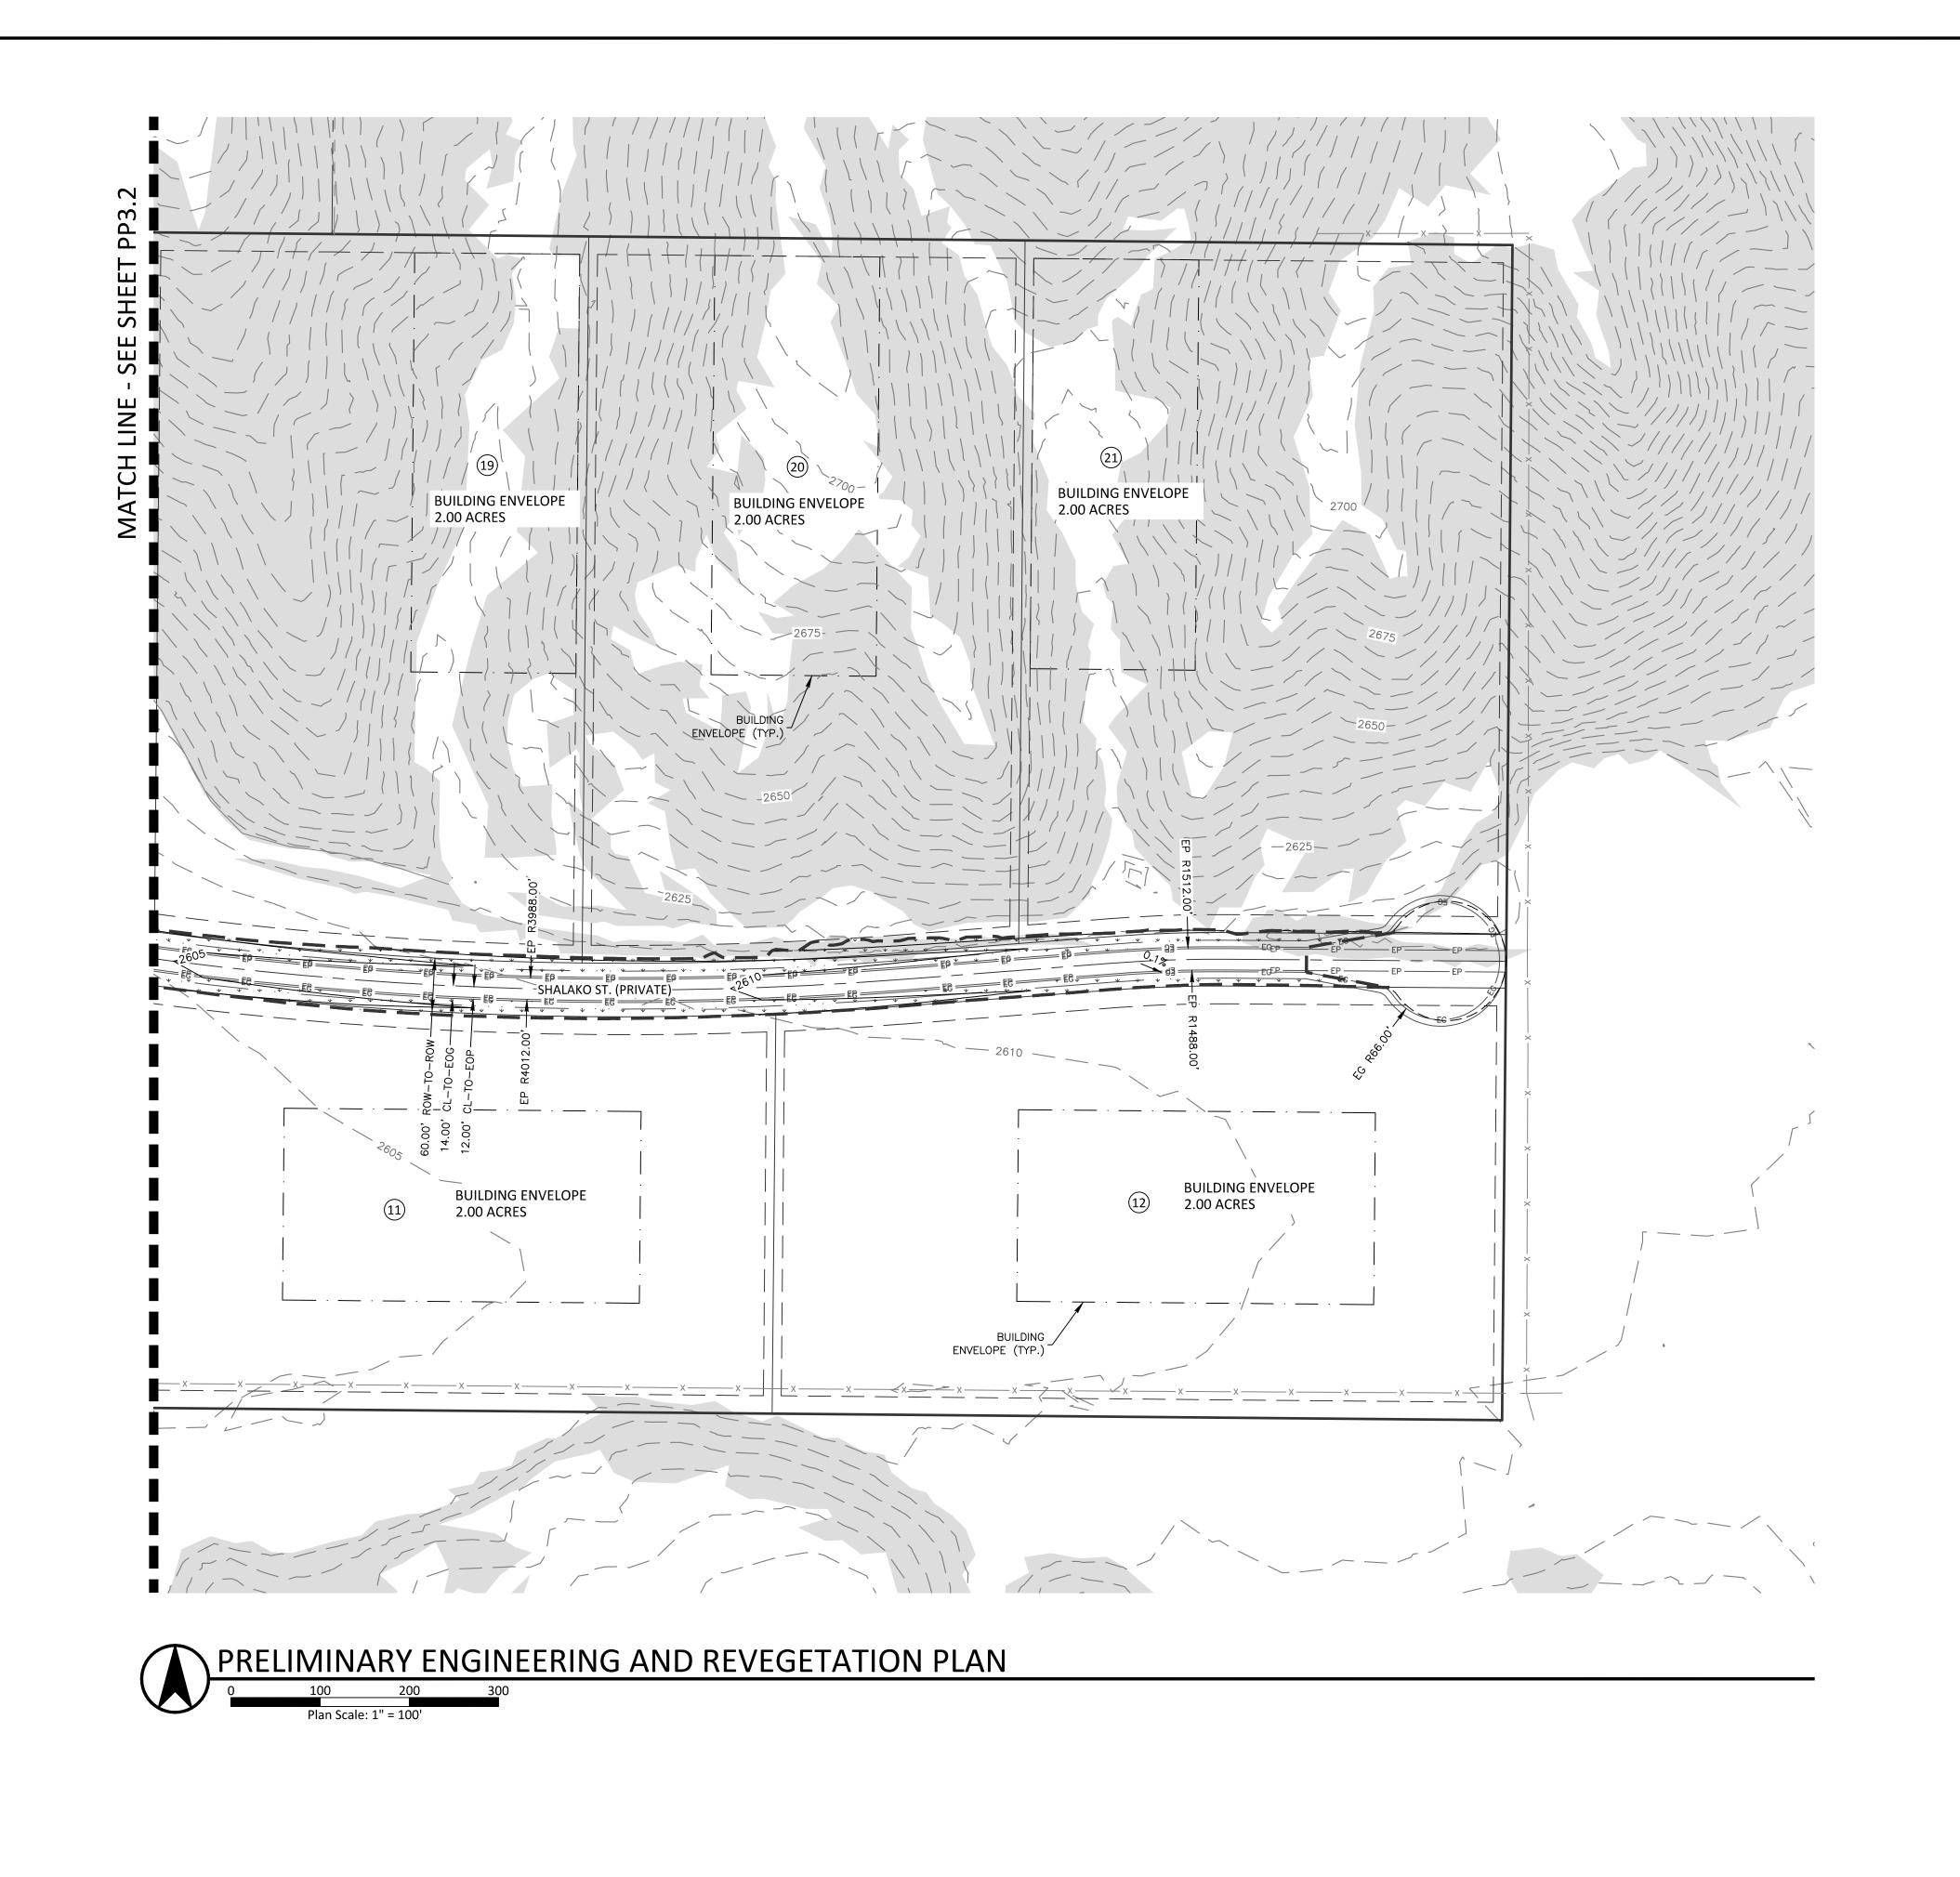
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AGENCY COMMENTS 4/21/23

ENGINEERING
5725 NORTH DISCOVERY WAY
BOISE, IDAHO 83713
PHONE (208) 639-6939
kmengllp.com

10821 4/21/23 DATE: 10/27/21 PROJECT: 18-168

DATE: 10/27/21
PROJECT: 18-168
SHEET NO.
PP3.2



GENERAL NOTES FIELD VERIFICATION OF QUANTITIES SHALL BE THE RESPONSIBILITY OF THE CONTRACTOR. DISTURBED AREAS ON REVEGETATION PLAN ARE SCHEMATIC. **GRADING LEGEND** 2900 _____ FINISHED GRADE CONTOUR

---- · --- · --- BUILDING ENVELOPE


AREA TO BE HYDROSEEDED

LIMITS OF GRADING

EXISTING SLOPES GREATER THAN 15%

RIDGELINE VISTAS SUBDIVISION PRELIMINARY ENGINEERING AND REVEGETATION PLAN CANYON COUNTY, IDAHO

REVISIONS ITEM AGENCY COMMENTS 6/1/22 AGENCY COMMENTS 11/29/22 AGENCY COMMENTS 4/21/23 AGENCY COMMENTS

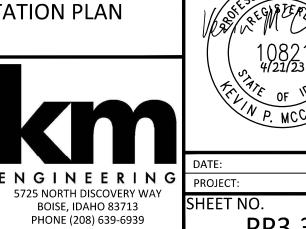

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PRELIMINAR)